

VALLE ESCONDIDO

VICINITY MAP

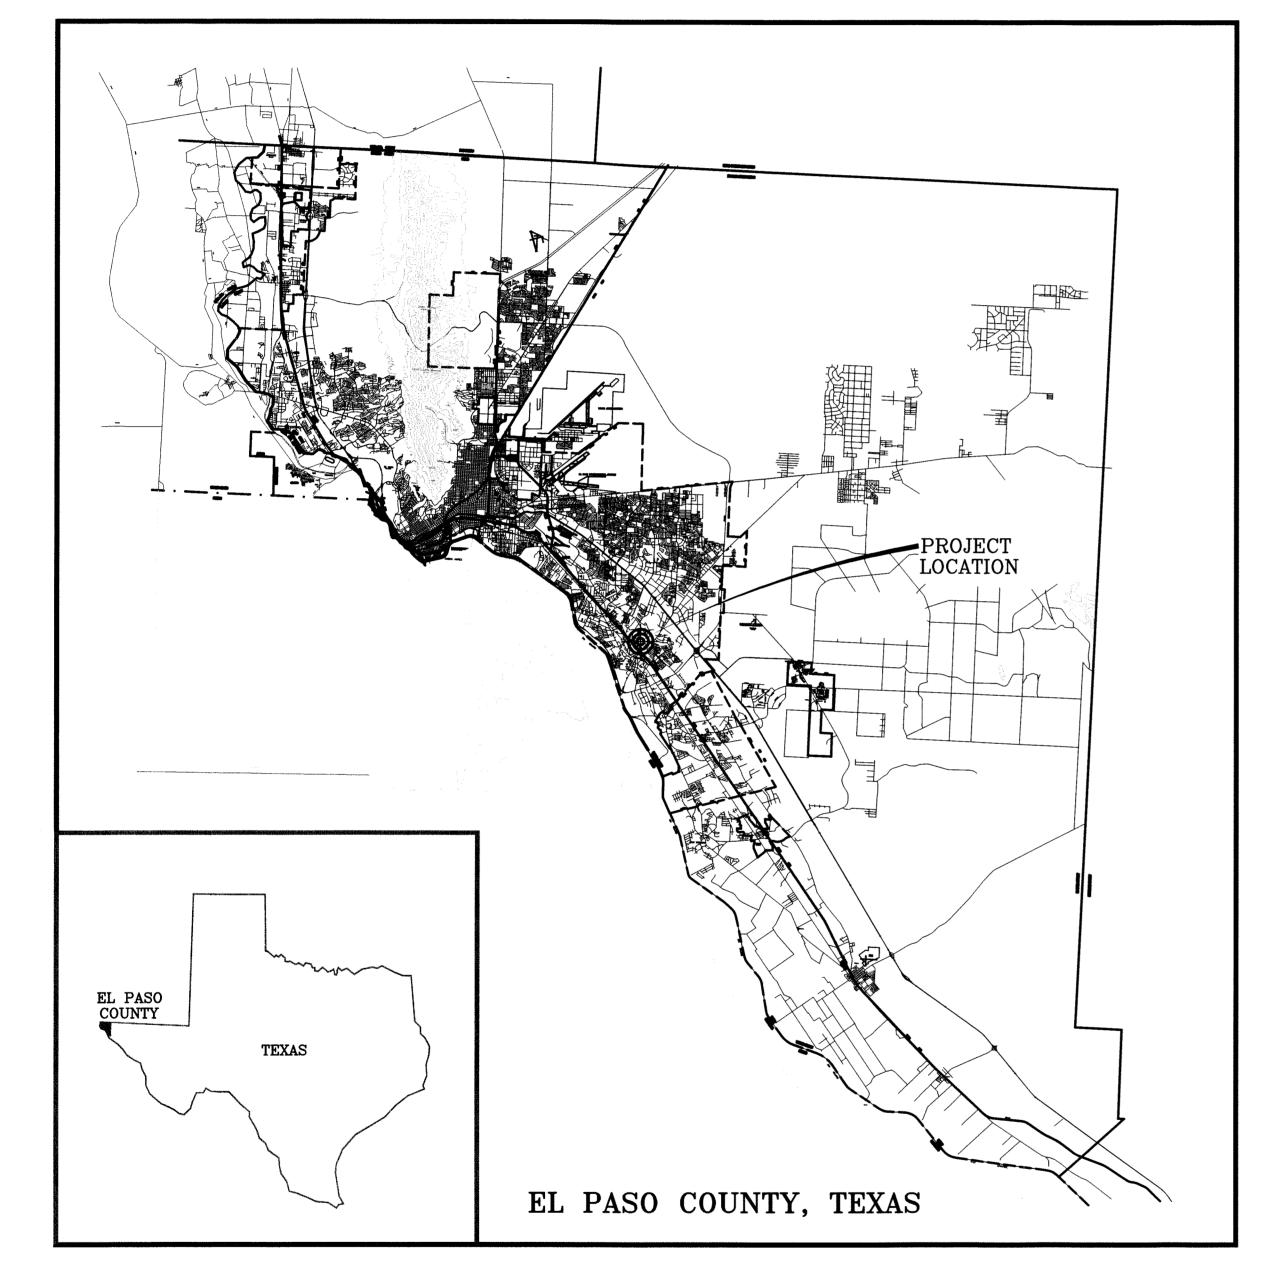

EVELOPMENT SERVICES DEPARTMENT

ADDRESSES: 208, 209, 212 & 213 PUERTA DE HIERRO COURT

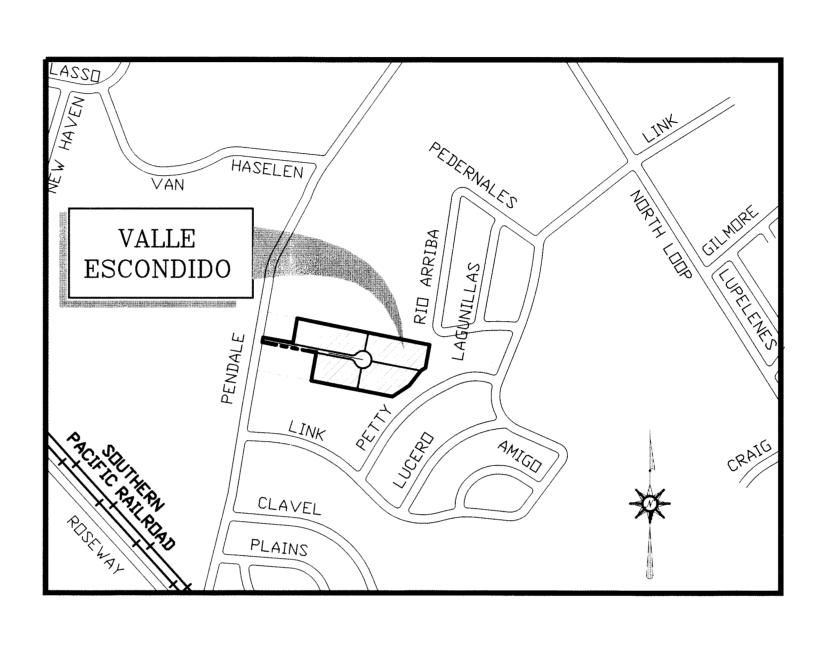

LOCATION MAP SCALE 1"= 500'


IMPROVEMENT PLANS

I N D E X

TITLE	SH	EET N	O.
COVER SHEET	1	OF	8
PLAT	2	OF	8
GRADING PLAN	3	OF	8
GRADING SECTIONS	4	OF	8
GRADING SECTIONS	5	OF	8
DRAINAGE PLAN	6	OF	8
S. W. P. P. PLAN	7	OF	8
S. W. P. P. PLAN STANDARD DETAILS	8	OF	8

CONSULTING COMPANY
1790 LEE TREVINO DRIVE SUITE 503
EL PASO, TEXAS 79936
TEL (915) 633-6422



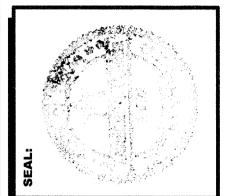

COVER SHEET

SHT. 1 OF 8

PROP. ELEV.

PROP., ELEV.

MATCH EXIST. PAVEMENT—
WITH PROPOSED NEW
PAVEMENT

- ANY CAVITY REMAINING OPEN DURING NONWORKING HOURS MUST BE GUARDED BY FLASHER TYPE BARRICADES WITH STRINGERS PLACED BETWEEN THE TOPS OF THE BARRICADES.
- DEVELOPER SHALL COMPLY WITH SECTION 13.08.170 "EXCESSIVE PAVING CUTS" AS PER EL PASO MUNICIPAL CODE.

GENERAL EARTHWORK NOTES

- ALL GRADING SHALL CONFORM TO THE CITY OF EL PASO GRADING ORDINANCE SECTION 18.44.
- THE CONTRACTOR SHALL CARRY ON HIS WORK WITH SPECIAL CARE AT ALL TIMES TO MAINTAIN THE NATURAL SURROUNDINGS AND EXISTING STRUCTURES IN AN UNDAMAGED CONDITION.
- NATURAL SUBGRADES TO SUPPORT STRUCTURAL FILL OR PAVEMENTS SHOULD BE STRIPPED OF ALL VEGETATION OR ORGANIC TOPSOIL. THE EXPOSED SUBGRADE SHOULD BE SCARIFIED JUST PRIOR TO FILL PLACEMENT TO A MINIMUM DEPTH OF 6 INCHES AND RECOMPACTED TO A MINIMUM OF 95% OF MAXIMUM DENSITY AS PER ASTM D-1557. ALL BACKFILL MATERIAL TO BE PLACED IN HORIZONTAL LAYERS NOT TO EXCEED EIGHT (8")INCH LIFTS AND COMPACTED AS BEFORE.
- TEMPORARY DUST AND EROSION CONTROL MEASURES SHALL BE PROVIDED FOR AT ALL TIMES. SEE SHEET 6 OF 10.
- ANY EROSION OF THE GRADED SITE DURING THE COURSE OF THE PROJECT SHALL BE CORRECTED PRIOR TO FINALIZATION OF THE PROJECT AT NO COST TO THE OWNER.
- ALL SLOPES AND SWALES WITHIN LOTS SHALL BE MAINTAINED BY

CONSTRUCTION NOTES:

- ALL CONCRETE FOR STRUCTURES SHALL BE 3000 PSI. UNLESS OTHERWISE NOTED.
- MINIMUM COVER FOR REINFORCING STEEL SHALL BE 2" UNLESS
- 95% COMPACTION REQUIRED FOR STRUCTURES AS PER ASTM
- REINFORCING SHALL CONFORM TO THE REQUIREMENTS OF ASTM A615 GRADE 60.
- RETAINING WALLS WILL BE REQUIRED WHERE THERE IS A GRADE DIFFERENCE OF 2 OR MORE FEET BETWEEN LOTS AND STREET. RETAINING WALL DESIGN AT TIME OF BUILDING PERMIT.
- 85% COMPACTION REQUIRED ON CUTS & 95% COMPACTION REQUIRED ON FILLS.

REV. DATE: AUGUST 31, 2010 REV. DATE: JUNE 16, 2010

WARNING! BEFORE YOU DIG

CONTRACTOR SHALL FIELD LOCATE ALL EXISTING UNDERGROUND IMPROVEMENTS IN PROJECT AREA

CONTRACTOR SHALL COORDINATE WITH ALL UTILITY COMPANIES PRIOR TO ANY EXCAVATION AND/OR POSSIBLE RELOCATION OF UTILITIES ENCOUNTERED

LISTING OF UTILITIES TO BE CONTACTED: EL PASO WATER UTILITIES.....1-915-594-5527 EL PASO ELECTRIC COMPANY......1-915-543-5720 TEXAS GAS SERVICE1-915-544-6300 .1-800-286-8343

...1-915-772-1123 TIME WARNER CABLE.. T.E.S.S. (MEMBER UTILITIES)......1-800-852-3786 NOTES:

CITY MONUMENT AT P.I. IN FRONT


OF 433 RIO ARRIBA DRIVE.

ELEVATION: 3664.67

1. THIS PROPERTY LIES IN ZONE "X", AREAS DETERMINED TO BE OUTSIDE THE 0.2% ANUAL

CHANCE FLOODPLAIN, PANEL # 480214-0048 C, DATED FEBRUARY 16, 2006.

VALLE-ESCONDIDO-GR.DWG ORIG. DATE: JUNE 01, 2010

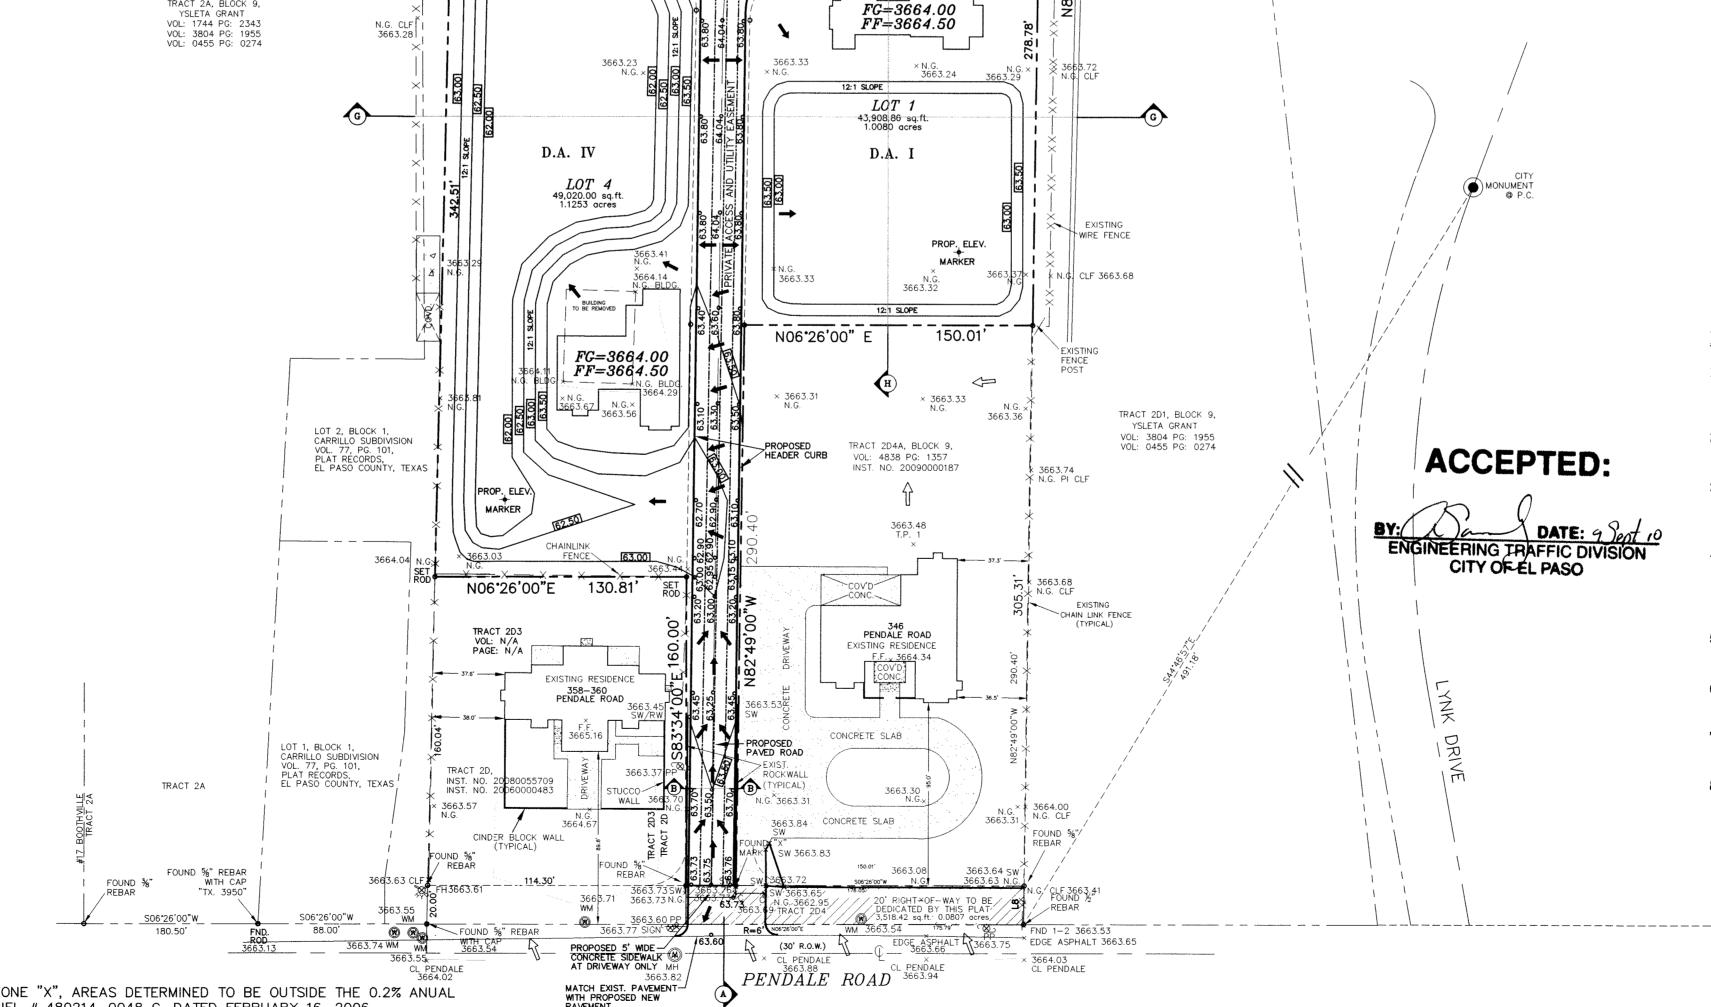

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CONSULTING COMPANY

1790 LEE TREVINO DRIVE SUITE 503

EL PASO, TEXAS 79936

TEL (915) 633-6422

1. 6' MAX. ALONG REAR & SIDE YARDS. 2. 3'-6' MAX. ALONG FRONT YARDS 3. 6' HIGH AT DRAINAGE AND BASINS GRADE LOT AWAY FROM ROCKWALL ≥ 2 CU. FT. -4" CLAY PIPE CRUSHED GRAVEL AT WHERE NOTED DRAIN 3000 P.S.I. CONC. CORE TEST @ 28 DAYS. 2 #4 REBARS-MIN. ROCKWALL DETAIL

ROCKWALL NOTES:

STONE FOR ROCKWALLS SHALL BE AS NEARLY UNIFORM IN SECTIONS AS IS PRACTICABLE. THE STONE SHALL BE DENSE AND RESISTANT OF AIR AND WATER.

SCALE: 1"=2'


- MORTAR MUST BE TYPE "S" 1800 P.S.I. AS PER ASTM C270.
- MASONRY WALLS OVER SIX (6) FEET IN HEIGHT AND THOSE USED FOR EARTH RETENTION OVER TWO (2) FEET MUST BE DESIGNED AS STRUCTURAL WALLS.
- WALLS ADJACENT TO PONDING AREAS OR DRAINAGE DITCHES MAY BE CONSTRUCTED OF BRICK, CINDER BLOCK, STONE OR OF CINDER BLOCK AND SHALL NOT BE LESS THAN SIX (6) FEET HIGH.
- ROCKWALL MORTAR JOINTS MUST NOT EXCEED TWO (2)
- PROVIDE ONE (1) INCH EXPANSION JOINTS AT EVERY 100
- ALL STONE SHALL BE THOROUGHLY SOAKED BEFORE BEING
- PLACED.
- NO RIVER ROCK SHALL BE ALLOWED.

ISIDRO BAQUERA JR. 9365 SAN LORENZO EL PASO, TEXAS 79907 PHONE: (915) 591-3312

SCHOOL DISTRICT

YSLETA INDEPENDENT SCHOOL DISTRICT

325 SIMS DRIVE 79925

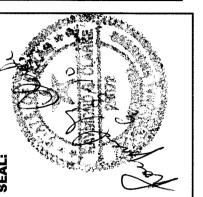


GRADING PLAN

CITY OF CONTAINING:

JUNE 2010 AS SHOWN

SHEET NO. :

SHT. 3 OF 8

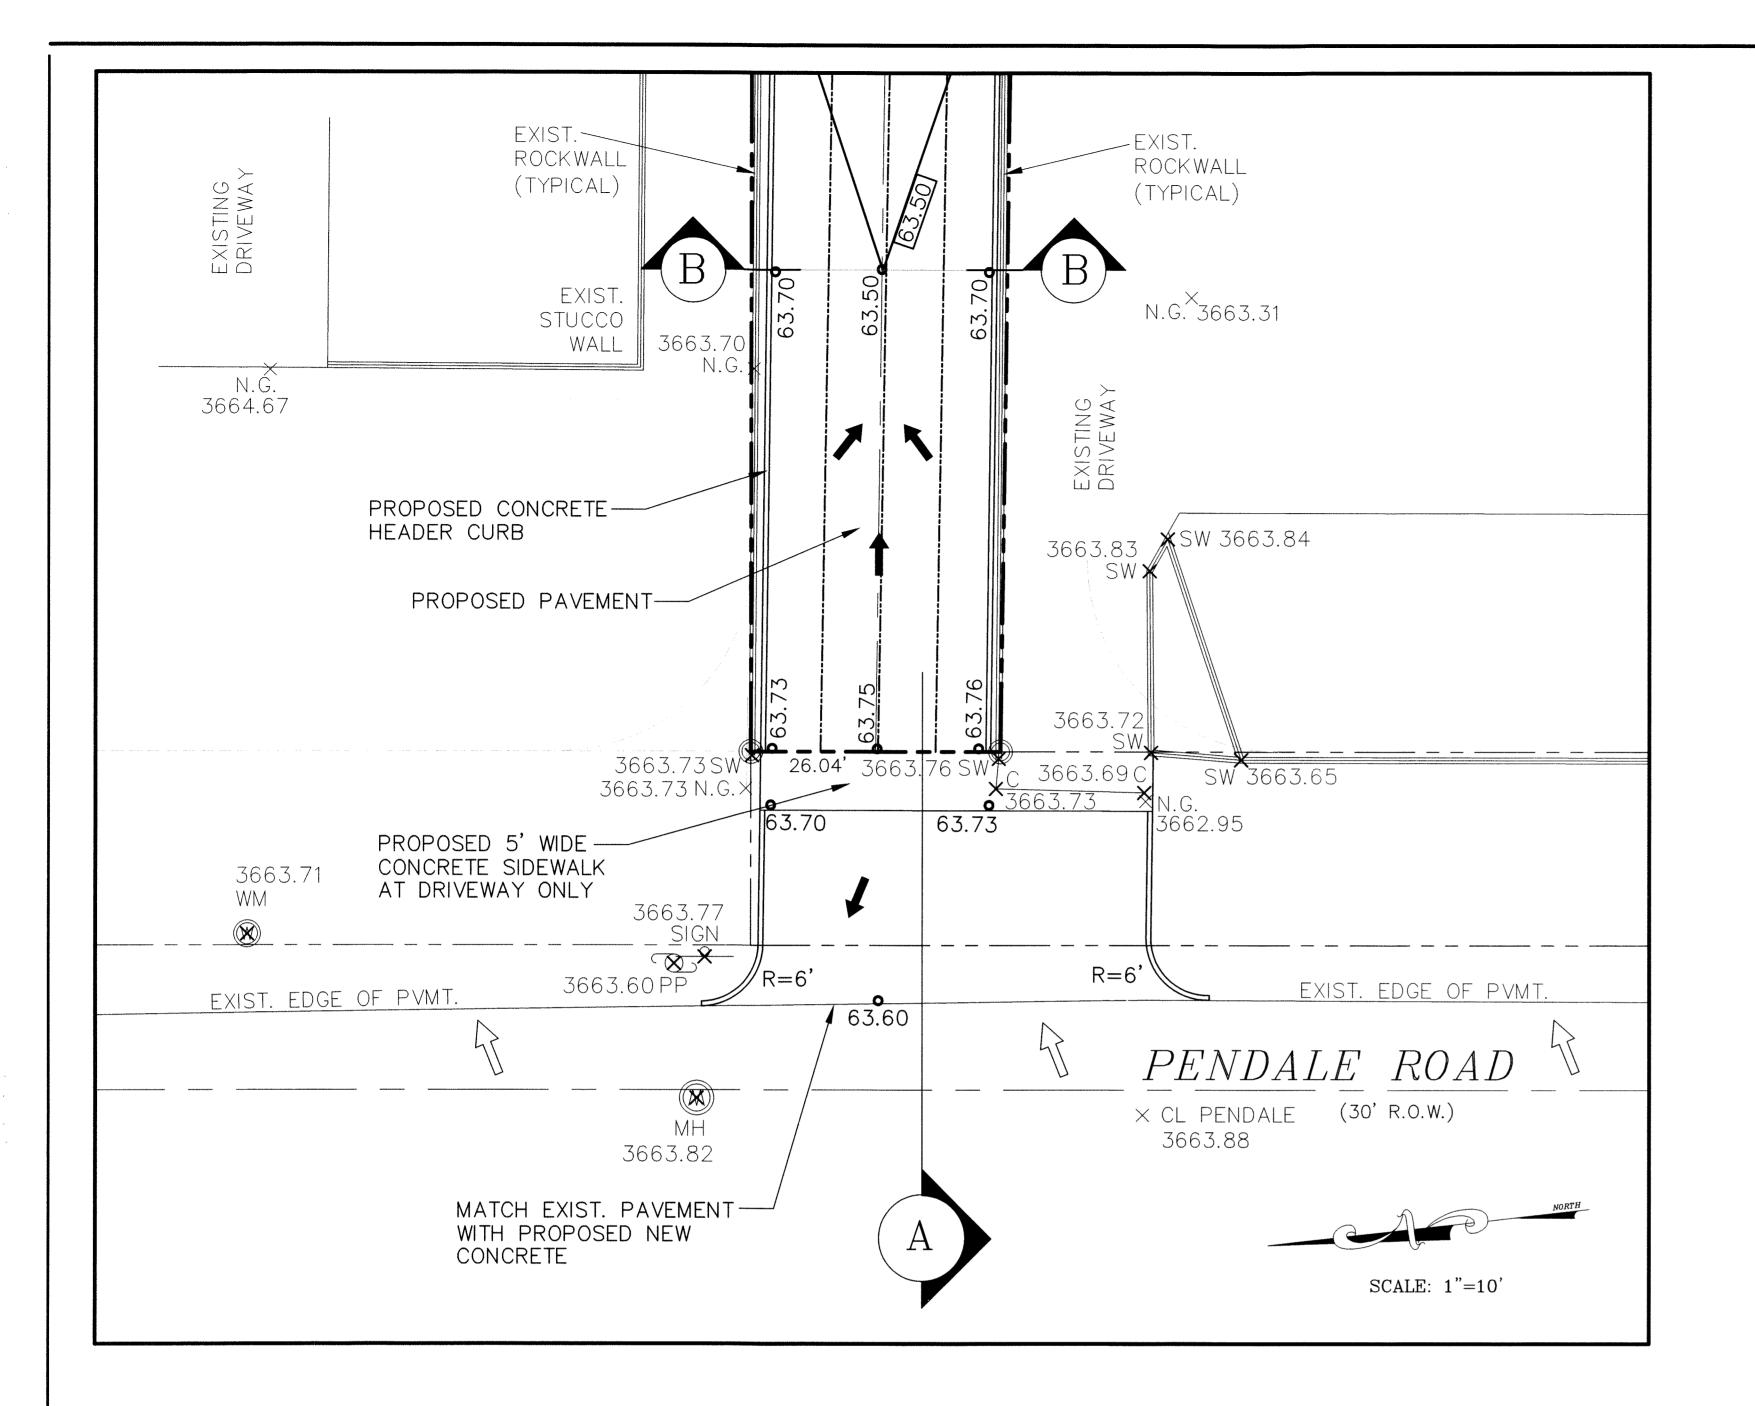

BASE COURSE-

PAVEMENT TERMINUS

SCALE: 1"=1'

R.O.W. PAVEMENT SECTION

SCALE: 1"=1'

12"

CRUSHED


AGGREGATE


BASE COURSE

COMPACTED

SUBGRADE

SUBGRADE-

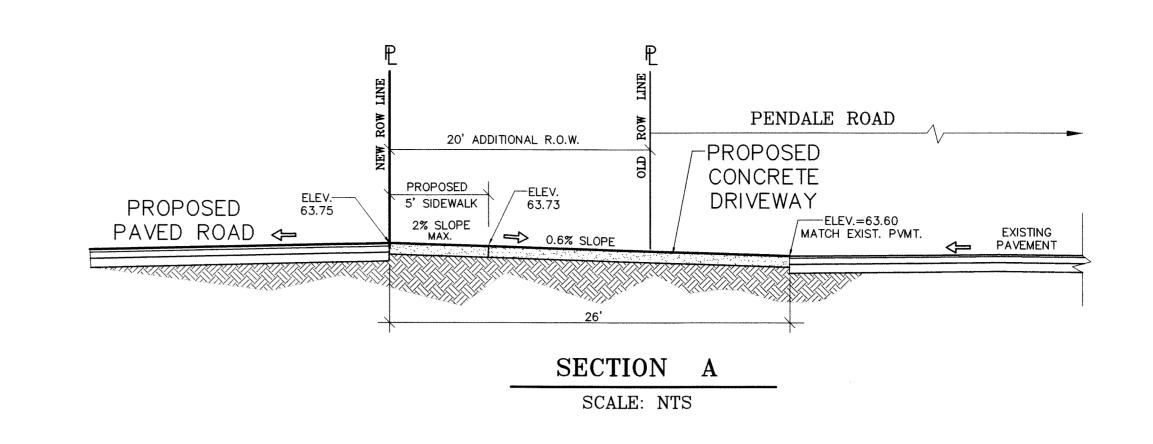

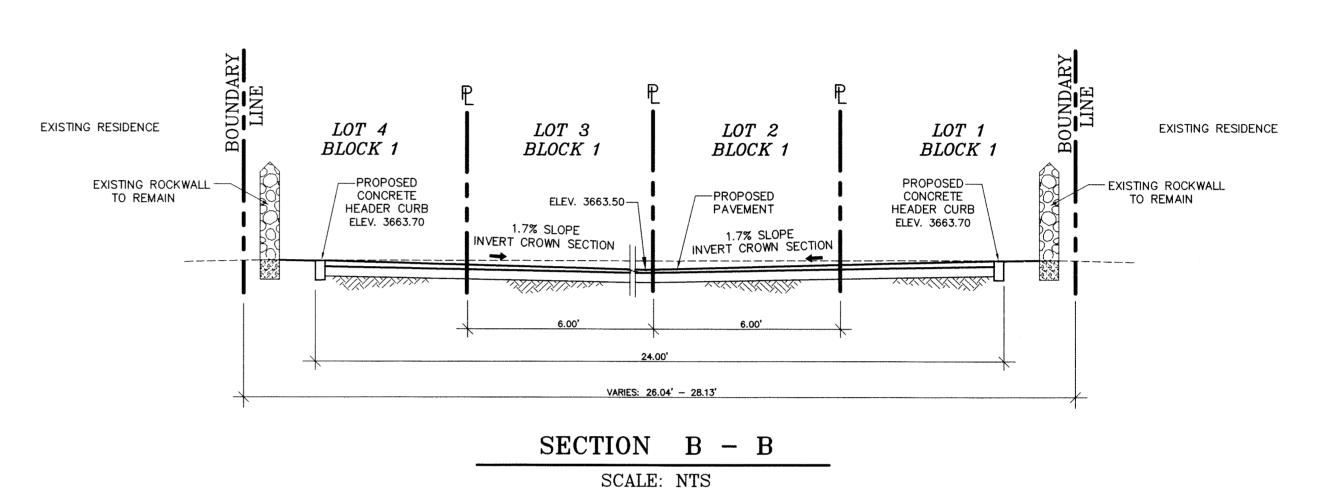


1.) 6' MAX. ALONG REAR AND SIDE YARDS. 2.) 3'-6" MAX. **ALONG** FRONT YARDS. 4" PIPE DRAIN @ 10' O.C. **EXISTING** GROUND -3000 P.S.I. CONC. CORE TEST @ 28 DAYS. -2 #4 REBARS

SCALE: 1'' = 2'

GENERAL NOTES 1. NATURAL STONE SHALL BE SOUND AND FREE FROM LOOSE OR FRIABLE INCLUSIONS AND SHALL MEET REQUIRED STRENGTH AND DURABILITY FOR PROPOSED USED.

- 3. CONCRETE SHALL BE F'C = 3000 PSI AT 28 DAYS.
- 6. WALL FOOTING SHALL BEAR ON FIRM UNDISTURBED OR COMPACTED GROUND (95% COMPACTION AS PER ASTM D1557).
- 7. CHANGES IN ALL DIRECTION, WALL HEIGHT OR FOOTING ELEVATION WILL REQUIRE ADDITIONAL DESIGN. 8. BACKFILL MATERIAL SHALL CONSIST OF WELL-DRAINED, COARSE
- GRAINED SOILS, OR FINE SILTY SANDS WITH NO CLAY CONTENT. BACKFILL MATERIAL SHALL EXERT A HORIZONTAL FORCE OF AN EQUIVALENT FLUID PRESSURE NOT TO EXCEED 30#/ft. 9. SURCHARGE LOADS WILL REQUIRE ADDITIONAL DESIGN.

- 1. The Contractor shall visit and familiarize himself with the Project Site prior to submitting his bid.
- 2. The Contractor shall schedule and perform his work so as to insure the safe and sufficient passage of stormwater runoff during the course of his operations. All required labor, tools, equipment, and supervision shall be considered incidental to the Work and shall be provided at no additional cost to Owner.
- 3. The Contractor shall coordinate the construction schedule with the Owner, all affected utility companies, and all other entities having jurisdiction over the Project.
- 4. The Contractor shall verify all dimensions and grades prior to commencing with the Work. Any discrepancies noted shall be reported immediately to the Project Civil Engineer. Otherwise, the Contractor shall be held responsible for their correctness.
- 5. Vibratory rollers shall not be permitted on any phase of this
- 6. All Work on this Project shall be performed in strict conformance with all current safety codes and standards, including but not limited to OSHA requirements.
- 7. The existing topographic/boundary information on this drawing was obtained from a licensed registered surveyor, The Project Civil Engineer does not warrant the accuracy of this information.
- WARNING! Before excavating, Contractor shall locate and protect all underground utility lines. Contractor shall replace any utilities damaged during construction, at no additional cost to Owner.
- 9. Contractor shall water construction site area a minimum of twice a day to keep dust to a minimum — once in the morning and once in the afternoon. This shall also be done on weekends and holidays.
- 10. Contractor shall prevent the erosion of silt, sediment, and debris from the construction site onto adjacent properties and streets. This may be accomplished through the use of a geotextile fabric silt fence or other approved means.
- 11. Fill materials for site grading and backfill may consist of onsite and/or imported materials.
- 12. Contractor shall be responsible for the protection of existing improvements in the Project area and its vicinity. Any damages resulting from Contractor's Work shall be repaired to its original condition by the Contractor at no cost to Owner.
- Contractor shall insure the following: All accessible routes shall not exceed a running slope greater than 1:20. Nowhere shall the cross slope of an accessible route exceed 1:50. Maximum slopes of adjoining gutters, road surface immediately adjacent to the curb ramp, or accessible route shall not exceed 1:20. Parking spaces and access aisles shall be level with surface slopes not exceeding 1:50 in all directions. New wheelchair ramps shall not exceed a
- 14. Contractor shall comply with all federal, state and local environmental regulations during construction activity.
- 15. Contractor shall be responsible for any and all environmental fines resulting from his/her work and shall hold the owner harmless in

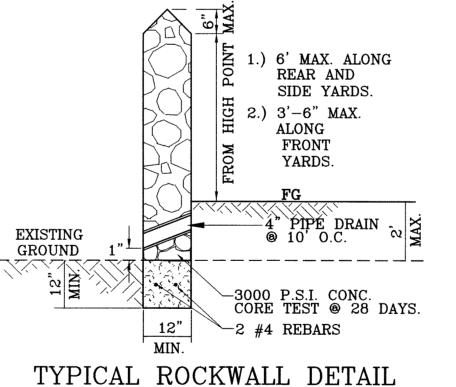

TYPICAL ROCKWALL DETAIL

- 2. MORTAR SHALL BE ASTMC-20 1800 PSI MORATR.
- 4. REINFORCING STEEL SHALL BE ASTM A 615 GRADE 40, FY = 40,000 PSI 5. ALLOWABLE SOIL BEARING PRESSURE = 2,000 PSF MINIMUM.

HIGHER VALUES SHALL BE USED.

THICKENED EDGE SHALL BE CONSTRUCTED

IN COURSES NOT OVER 4" IN THICKNESS,

EACH COURSE THOROUGHLY COMPACTED

BEFORE PLACING NEXT COURSE. FINAL

PAVEMENT.

COURSE TO BE PLACED MONOLITHIC WITH

IF THE RESULT FOR "CBR" VALUES ARE HIGHER

THAN THE MINIMUM PAVEMENT THICKNESS, THE

CONSULTING COMPANY 1790 LEE TREVINO DRIVE SUITE 503 EL PASO, TEXAS 79936 TEL (915) 633-6422

WARNING! BEFORE YOU DIG CONTRACTOR SHALL FIELD LOCATE ALL EXISTING UNDERGROUND IMPROVEMENTS IN PROJECT AREA CONTRACTOR SHALL COORDINATE WITH ALL UTILITY COMPANIES PRIOR TO ANY EXCAVATION AND/OR POSSIBLE RELOCATION OF UTILITIES ENCOUNTERED LISTING OF UTILITIES TO BE CONTACTED: EL PASO WATER UTILITIES.....1-915-594-5527 EL PASO ELECTRIC COMPANY......1-915-543-5720

. CONCRETE CURB AND RETURNS SHALL BE 3,000 P.S.I. MIN.

IS REQUIRED FOR ALL CURB RETURNS. TRIM BITUMINOUS

5. EXPANSION JOINTS REQUIRED AT 50' O.C. AND AT CURB

MATERIAL 1/4" LESS THAN NEAT CURB DIMENSION.

. SUBGRADE UNDER CURB MUST BE FORMED AND

3. 1/2" PREMOLDED BITUMINOUS EXPANSION JOINT (AASHTO M-33)

2. DUMMY JOINT REQUIRED AT 10' O.C.

COMPACTED TO 95% ASTM D1557.

REV. DATE: AUGUST 31, 2010

REV. DATE: AUGUST 6, 2010


RETURNS WHEN FORMING FOR CURBS.

TEXAS GAS SERVICE..... ...1-915-544-6300 1-800-286-8343 ...1-915-772-1123 TIME WARNER CABLE T.E.S.S. (MEMBER UTILITIES)......1-800-852-3786

VALLE-ESCONDIDO-GR-SEC.DWG ORIG. DATE: JUNE 01, 2010

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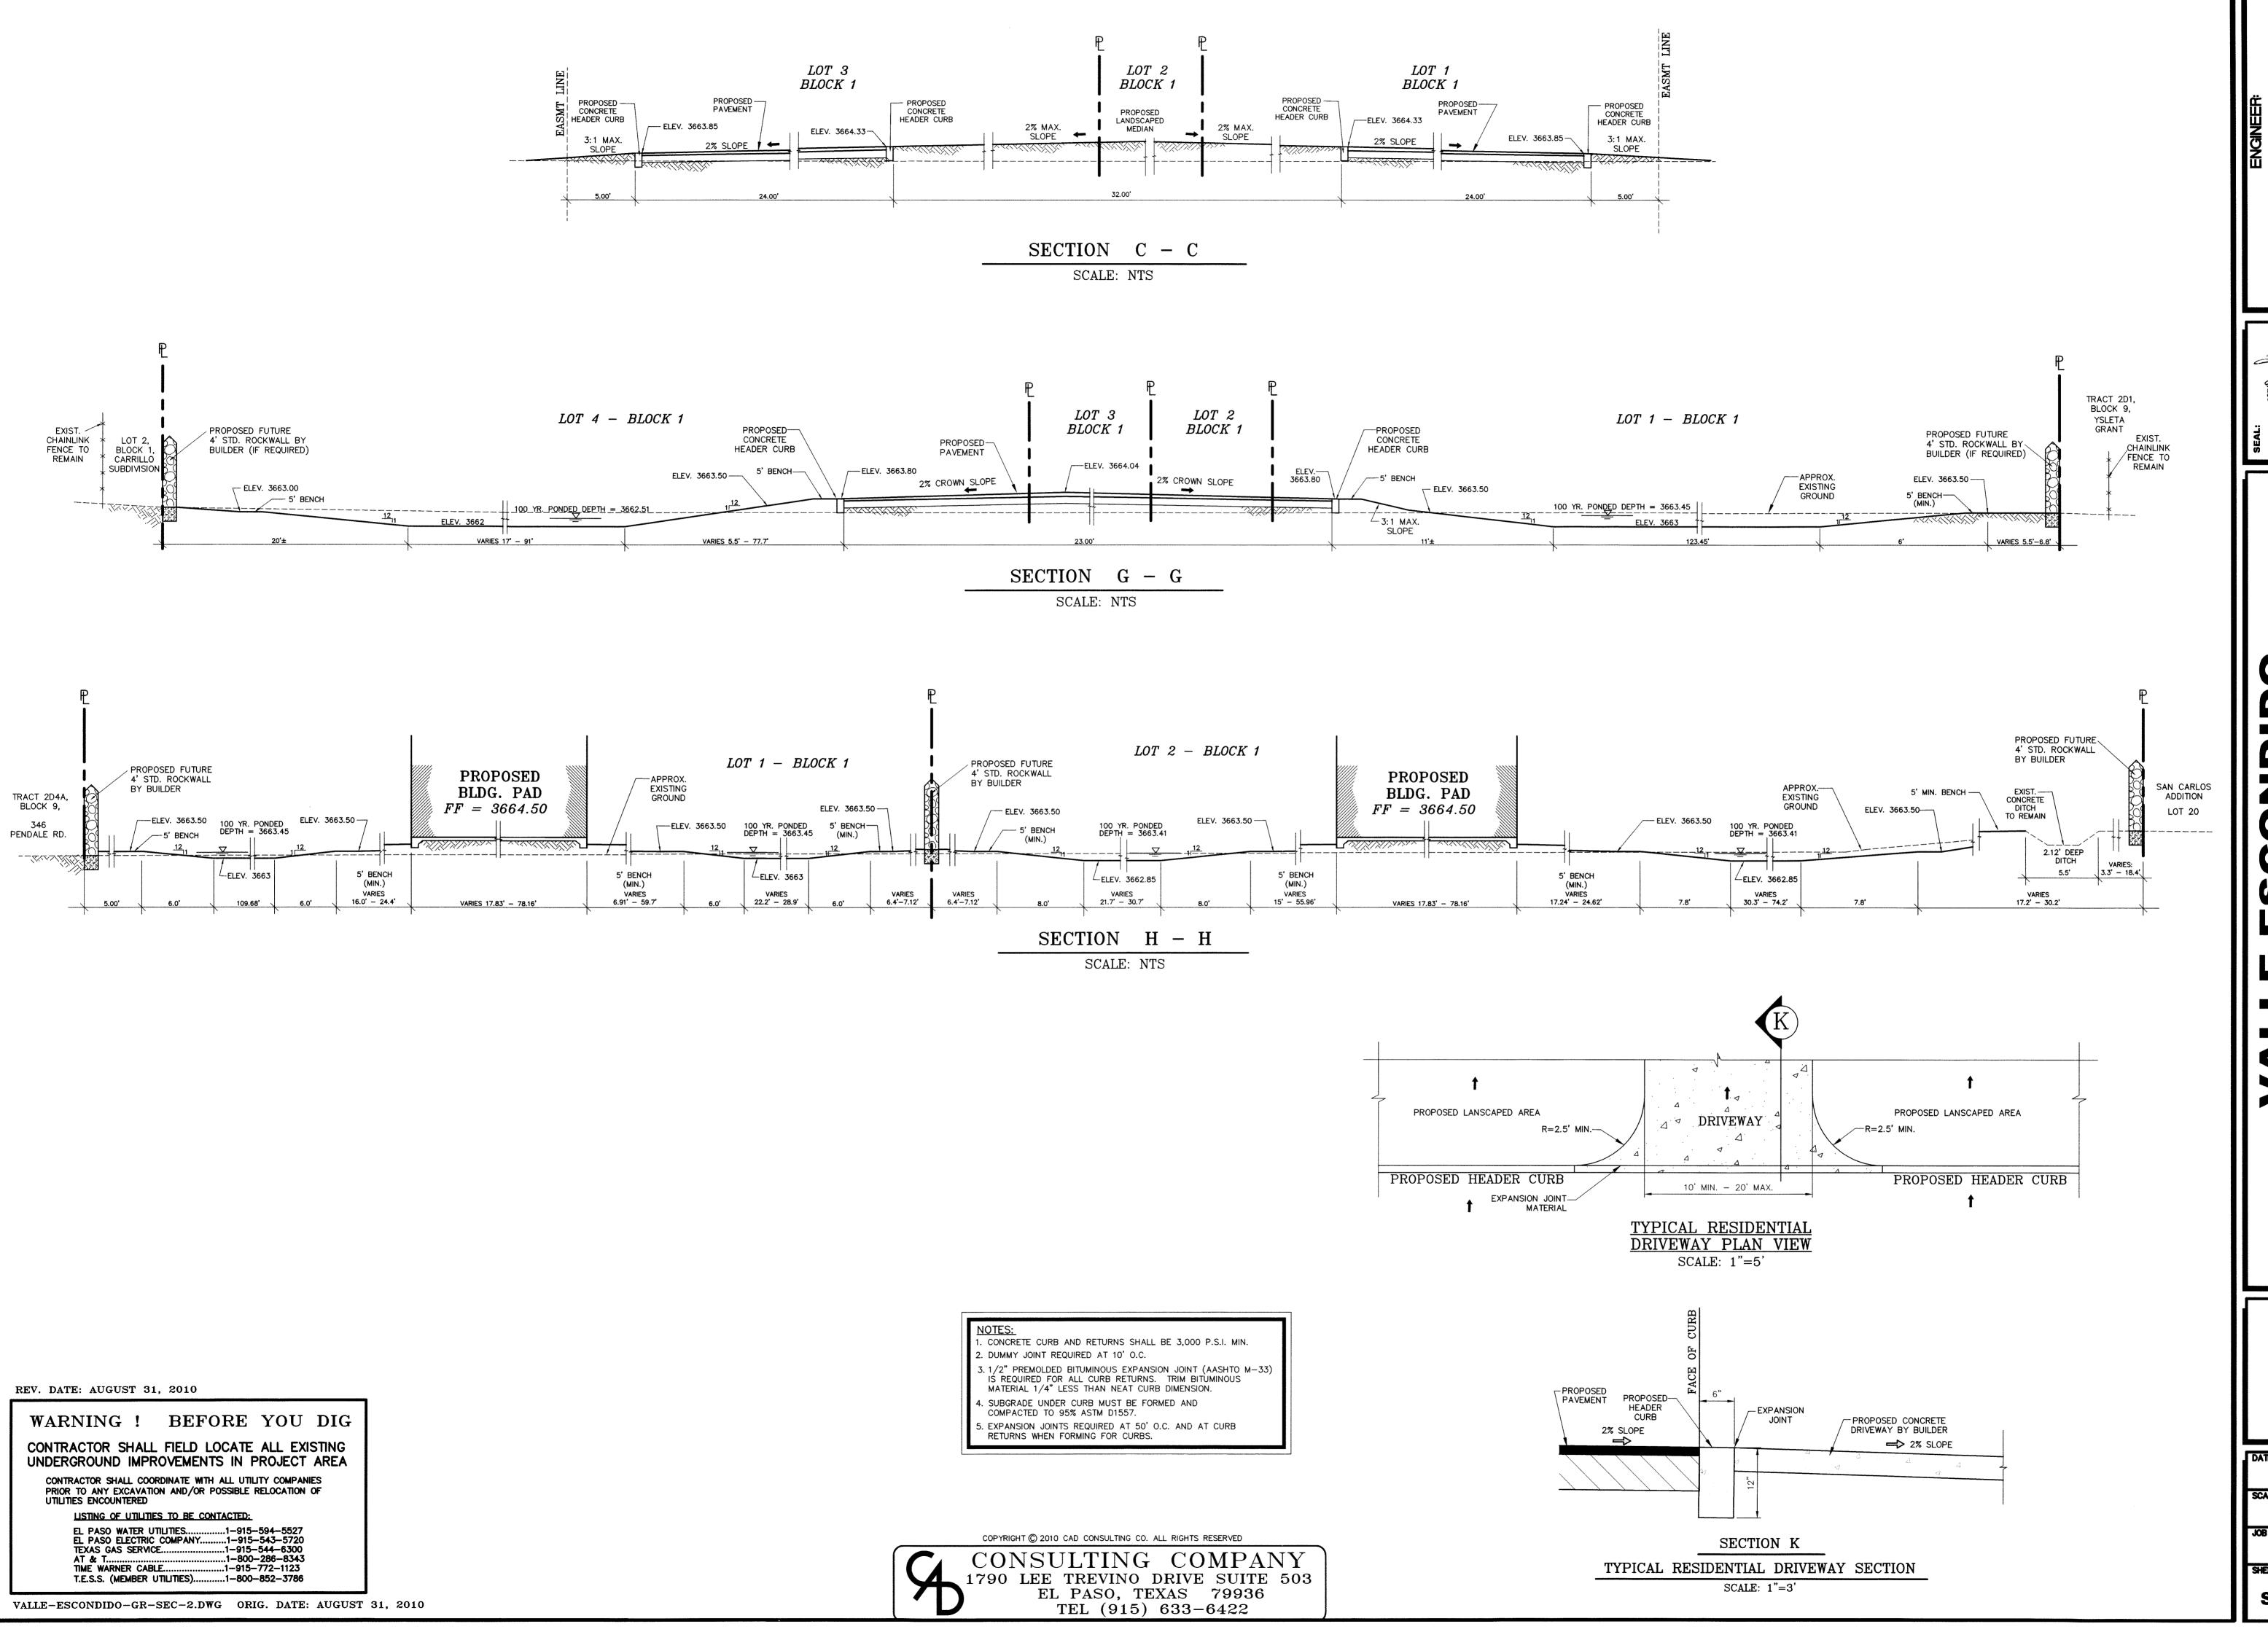
BEIN


GRADING **SECTIONS**

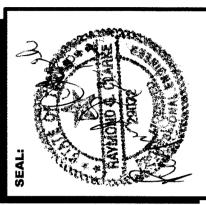
JUNE 2010

AS SHOWN

SHT. 4 OF 8



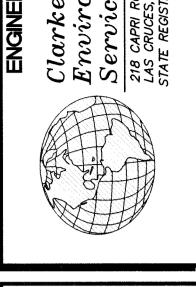


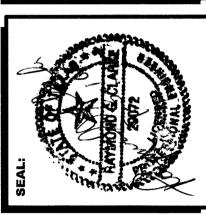

GRADING SECTIONS

JUNE 2010 AS SHOWN

SHT. 5 **OF** 8

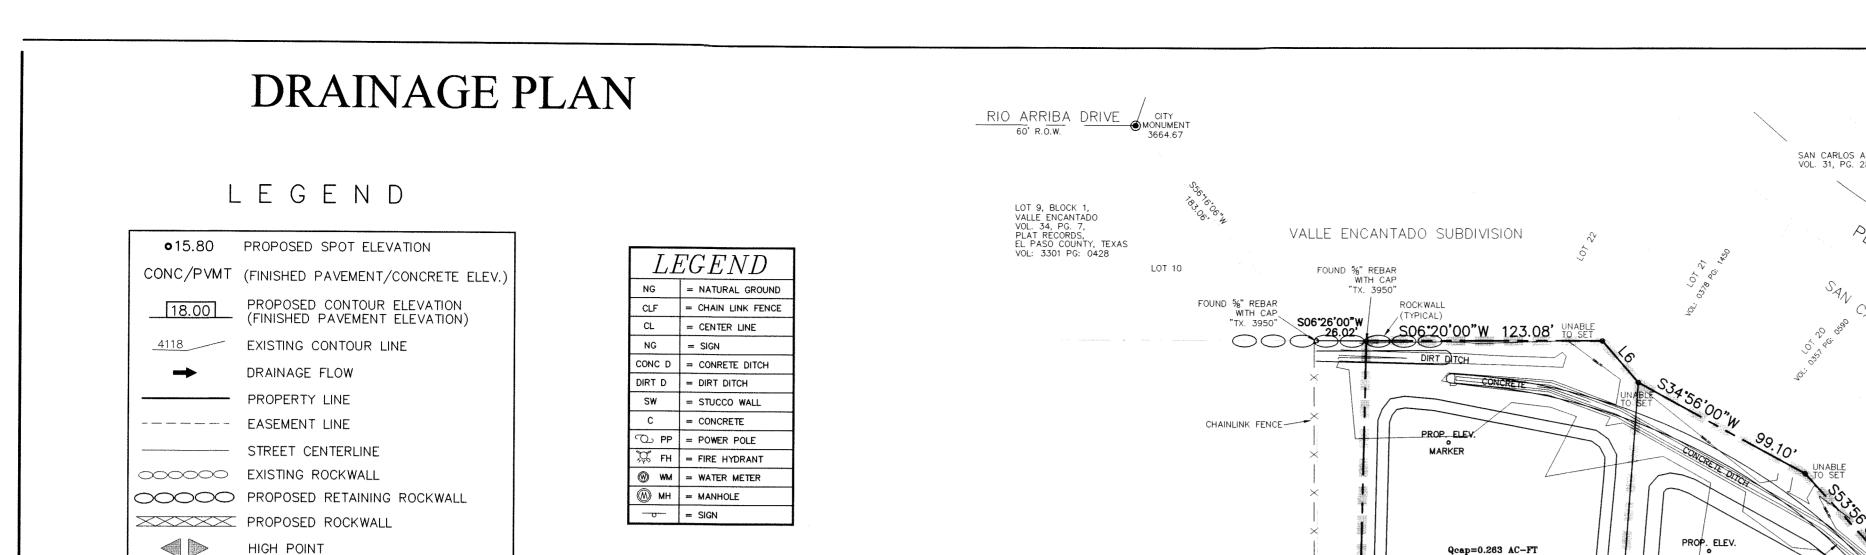

GRAPHIC SCALE

1 inch = 50 ft.

LEGEND

(ACRES)

HIGH POINT

LOW POINT

PROPOSED DRAINAGE AREA

DRAINAGE FLOW

RUN-OFF QUANTITY (CUBIC Ft/Sec)

WATERSHED AREA

DRAINAGE PLAN

JUNE 2010 SCALE: **AS SHOWN** JOB NO. :

SHEET NO. : SHT. 6 OF 8

ON SITE PONDING NOTES:

- 1.) PERMANENT ELEVATION MARKERS SHALL BE INSTALLED TO DEFINE THE LEVELS TO BE MAINTAINED TO ENSURE THE EFFECTIVENESS OF ON-SITE PONDING ON ALL RESIDENTIAL LOTS.
- 2.) PERMANENT ELEVATIONS MARKERS SHALL NOT BE MOVED, COVERED OR ALTERED WITHOUT WRITTEN PERMISSION FROM THE
- 3.) FILLING OR CHANGING THE LOT, OR ALLOWING THE LOT TO BE FILLED OR CHANGED TO AN ELEVATION GREATER THAN ESTABLISHED BY THE PERMANENT ELEVATION MARKERS, IS PROHIBITED.
- 4.) THE CITY SHALL BE GRANTED PERMANENT RIGHT OF ACCESS TO INSPECT THE LOT ELEVATION AND THE PERMANENT ELEVATION MARKERS
- 5.) NO MORE THAN FIFTY (50) PERCENT OF THE AREA OF THE RESIDENTIAL LOT CONVEYED BY THE DEED MAY EVER BE COVERED BY IMPROVEMENTS OF ANY KIND, EITHER TEMPORARY OR PERMANENT.
- 6.) DEVELOPER/BUILDER SHALL ALSO COMPLY WITH SECTION 19.16.060 -

DRAINAGE CALCULATIONS Q = C I A

4" P.V.C.

PERMANENT ELEVATION

MARKER (TYPICAL)

PROPOSED ELEVATION MARKER

FINISHED GRADE

MARKERS TO BE

DETERMINED BY

BACK YARDS. LOCATION TO BE

PLACED AT LOWEST

POINT OF FRONT &

VOLUME COMPUTATIONS Q = A R C / 12

WATERSHED AREA	AREA (AC)	Cw	t _c (min)	I ₁₀₀ (in/min)	$ m ^{Q_{100}}$ (CFS)		R	Qreq (AC-FT)	Qcap (AC-FT)	Ponded Depth
D.A. I	1.00	0.60	10.0	5.36	3.22		4.0	0.200	0.209 @ 3663.50	3663.45
D.A. II	0.96	0.60	10.0	5.36	3.09		4.0	0.192	0.202 @ 3663.50	3663.41
D.A. III	1.15	0.60	10.0	5.36	3.70		4.0	0.230	0.263 @ 3663.50	3663.38
D.A. IV	1.28	0.60	10.0	5.36	4.12		4.0	0.256	0.272 @ 3662.60	3662.51
D.A. V	0.13	0.95	10.0	5.36	0.66	֓֟֟֟֓֓֓֓֓֓֓֓֓֓֓֓֓֓֓֓֓֟֓֓֓֓֓֓֓֡֟֓֓֓֓֓֡֟֓֓֓֡֓				

0.61

AT S=1%, V=1 FT/SEC (VELOCITY CHART)

0.95

10.0

5.36

Tc = L / V(60) $I_{100} = 144.20 / (Te + 25.944)^{0.9190}$

0.12

REV. DATE: AUGUST 31, 2010 REV. DATE: AUGUST 6, 2010

BEFORE YOU DIG WARNING!

CONTRACTOR SHALL FIELD LOCATE ALL EXISTING UNDERGROUND IMPROVEMENTS IN PROJECT AREA CONTRACTOR SHALL COORDINATE WITH ALL UTILITY COMPANIES PRIOR TO ANY EXCAVATION AND/OR POSSIBLE RELOCATION OF

> LISTING OF UTILITIES TO BE CONTACTED: EL PASO WATER UTILITIES......1-915-594-5527 EL PASO ELECTRIC COMPANY......1-915-543-5720 TEXAS GAS SERVICE...

..1-915-544-6300 ..1-800-286-8343 TIME WARNER CABLE.. ..1-915-772-1123 T.E.S.S. (MEMBER UTILITIES).....1-800-852-3786

VALLE-ESCONDIDO-DR.DWG ORIG. DATE: JUNE 01, 2010

1. THIS PROPERTY LIES IN ZONE "X", AREAS DETERMINED TO BE OUTSIDE THE 0.2% ANUAL

CITY MONUMENT AT P.I. IN FRONT OF 433 RIO ARRIBA DRIVE. ELEVATION: 3664.67

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325 SIMS DRIVE 79925

OWNER: ISIDRO BAQUERA JR. 9365 SAN LORENZO EL PASO, TEXAS 79907 PHONE: (915) 591-3312

MONUMENT ® P.C.

PENDALE ROAD CHANCE FLOODPLAIN, PANEL # 480214-0048 C, DATED FEBRUARY 16, 2006.

S06*26'00"W

S06'26'00"W

180.50'

LOT 2, BLOCK 1, CARRILLO SUBDIVISION VOL. 77, PG. 101, PLAT RECORDS, EL PASO COUNTY, TEXAS —

TRACT 2A, BLOCK 9, YSLETA GRANT VOL: 1744 PG: 2343 VOL: 3804 PG: 1955 VOL: 0455 PG: 0274

CONSULTING COMPANY 1790 LEE TREVINO DRIVE SUITE 503 EL PASO, TEXAS 79936 TEL (915) 633-6422

SCHOOL DISTRICT

CITY MONUMENT @ P.C.

YSLETA INDEPENDENT SCHOOL DISTRICT

Qcap=0.263 AC-FT

FG=3664.00 FF=3664.50

D.A. III

FG=3664.00 FF=3664.50

12:1 SLOPE 63.50

44,838.28 sq.ft. 1.0293 acres

FG=3664.00 FF=3664.50

Qcap=0.171 AC-FT

N06'26'00" E 150.01'

TRACT 2D4A, BLOCK 9, VOL: 4838 PG: 1357 INST. NO. 20090000187

CONCRETE SLAB

CONCRETE SLAB

PROP. ELEV.


TRACT 2D1, BLOCK 9, YSLETA GRANT VOL: 3804 PG: 1955 VOL: 0455 PG: 0274

FF=3664.50


STORM WATER POLLUTION PREVENTION PLAN

STABILIZED ENTRANCE EROSION CONTROL NOTES

- SILT FENCING OR TEMPORARY BERMS SHALL BE INSTALLED AT TIME OF CONSTRUCTION.
- TEMPORARY SWALES AND DESILTING BASINS WILL BE PLACED WHERE NECESSARY IN ORDER TO CONVEY STORM WATER RUN-OFF.
- A STABILIZED CONSTRUCTION ENTRANCE WILL BE PROVIDED TO HELP REDUCE VEHICLE TRACKING OF SEDIMENTS. THE PAVED STREET ADJACENT TO THE SITE ENTRANCE WILL BE SWEPT WEEKLY TO REMOVE ANY EXCESS MUD, DIRT OR ROCK TRACKED
- THE OWNER SHALL BE RESPONSIBLE FOR INSURING THAT ALL EROSION CONTROL METHODS ARE INSPECTED ON A MONTHLY BASIS OR AFTER EVERY ERODIBLE RAINFALL (1/2" OR MORE) ANY NECESSARY REPAIRS OR CLEANUP TO MAINTAIN THE EFFECTIVENESSOF THE EROSION CONTROL SHALL BE MADE AT THE TIME.
- A TEMPORARY BERM SHALL BE PROVIDED AT THE TOE OF SLOPE AND LOT LINE AT TIME OF GRADING PRIOR TO ROCKWALL CONSTRUCTION.

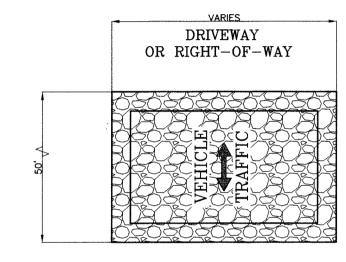


GRAVEL ENTRANCE SCALE: 1"=3'

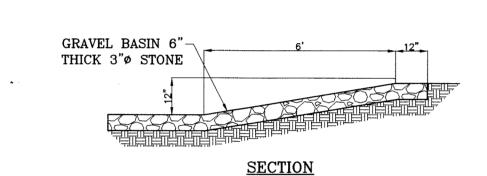

EROSION AND SEDIMENT CONTROLS TEMPORARY STABILIZATION SCALE: 1"=3'

LOCATION MAP

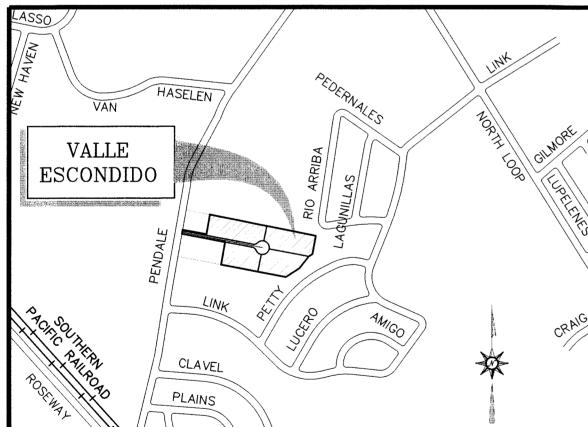

REV. DATE: AUGUST 31, 2010


WARNING! BEFORE YOU DIG

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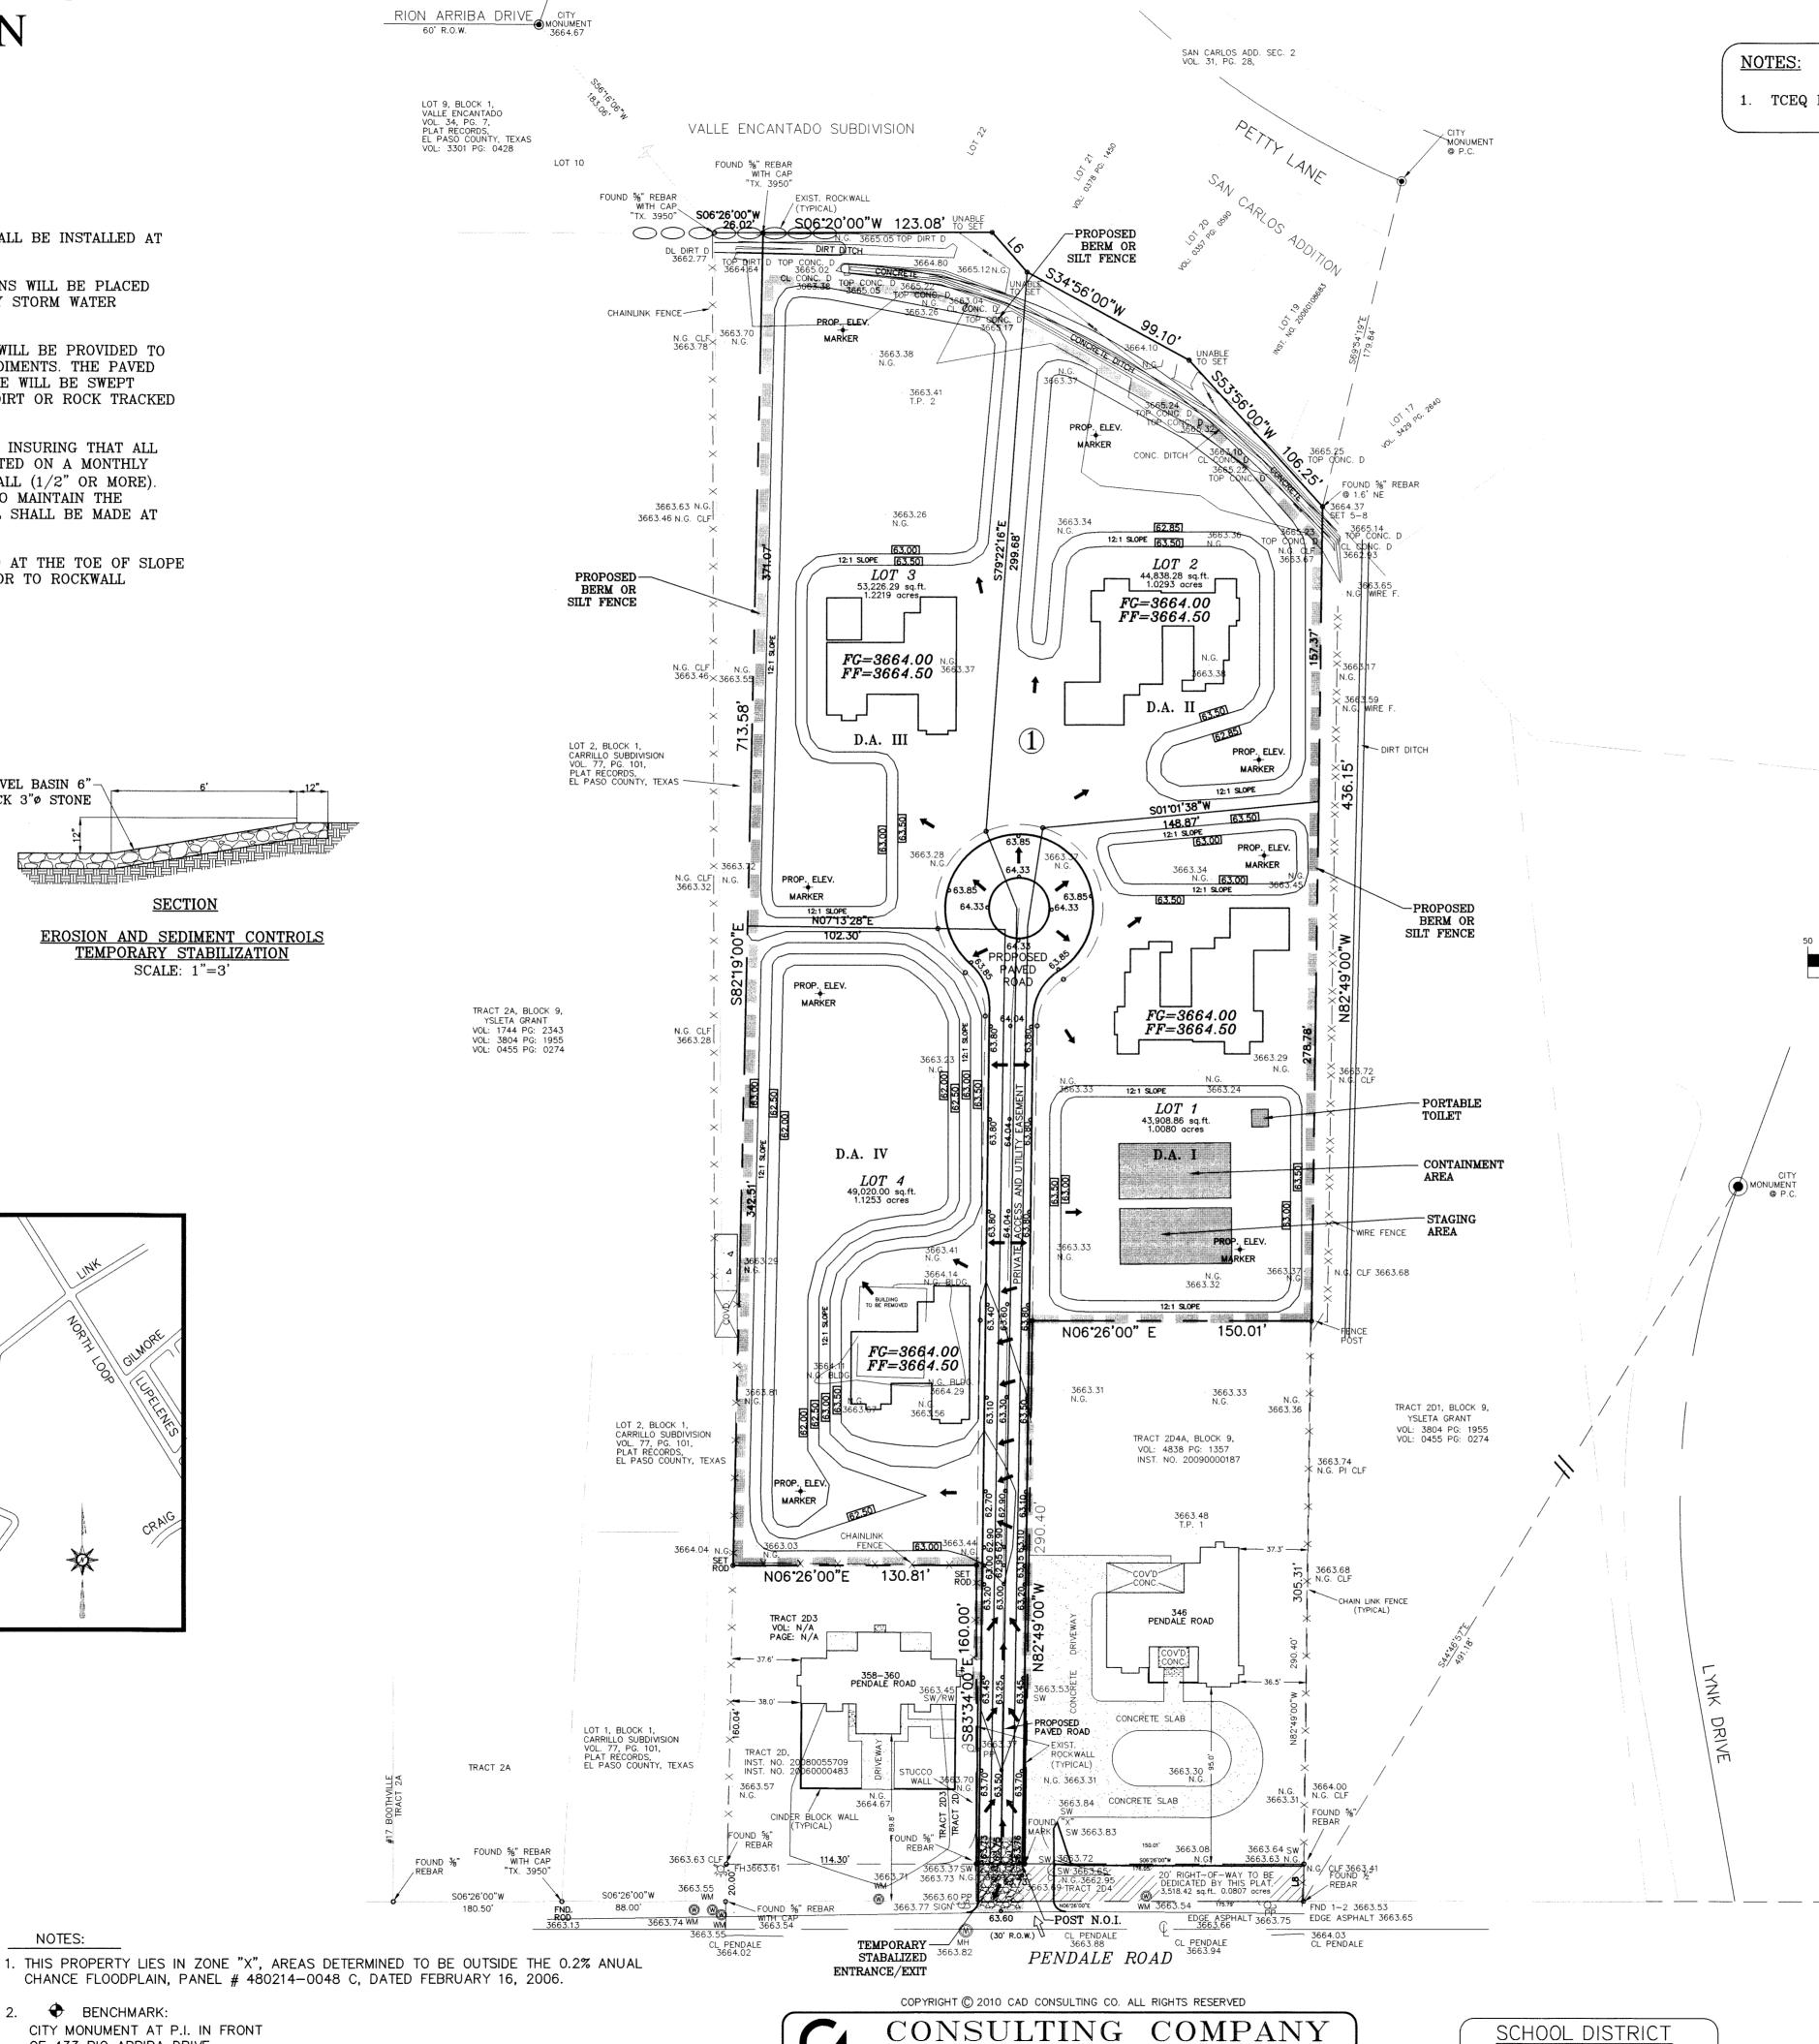
VALLE-ESCONDIDO-POL.DWG ORIG. DATE: JUNE 01, 2010



ELEVATION: 3664.67

CITY MONUMENT AT P.I. IN FRONT

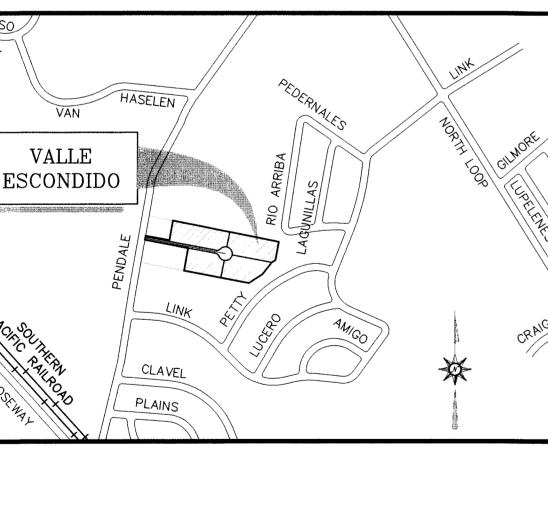OF 433 RIO ARRIBA DRIVE.



1790 LEE TREVINO DRIVE SUITE 503

EL PASO, TEXAS 79936

TEL (915) 633-6422

1. TCEQ NOI PERMIT- REQUIRED BY CONTRACTOR


LEGEND

•15.80 PROPOSED SPOT ELEVATION CONC/PVMT (FINISHED PAVEMENT/CONCRETE ELEV. [18.00] PROPOSED CONTOUR ELEVATION (FINISHED PAVEMENT ELEVATION) 4118 EXISTING CONTOUR LINE PROPOSED DRAINAGE FLOW PROPERTY LINE --- EASEMENT LINE STREET CENTERLINE ○○○○○ EXISTING ROCKWALL OOOO PROPOSED RETAINING ROCKWALL PROPOSED ROCKWALL PROPOSED ELEVATION MARKER PROPOSED TEMPORARY


SILT FENCE OR BERM



(IN FEET) 1 inch = 50 ft.

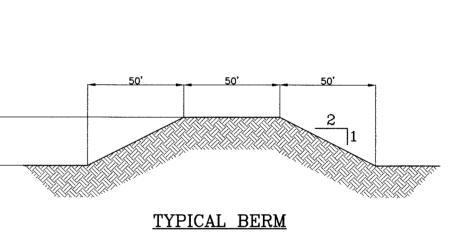

SCALE: 1"=3'

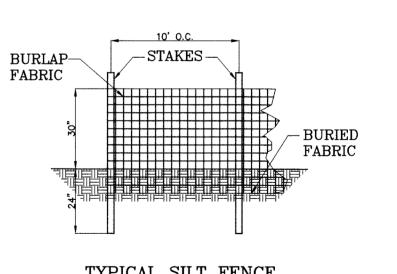

TYPICAL SILT FENCE SCALE: 1"=3'

OWNER: ISIDRO BAQUERA JR. 9365 SAN LORENZO EL PASO, TEXAS 79907 PHONE: (915) 591-3312

SCHOOL DISTRICT

325 SIMS DRIVE 79925

YSLETA INDEPENDENT SCHOOL DISTRICT

STORM WATER **POLLUTION PREVENTION PLAN**

	DATE:
	JUNE 2010
	SCALE:
	AS SHOWN
	JOB NO. :
	SHEET NO. :
١	SHT. 7 OF 8

STORM WATER POLLUTION PREVENTION PLAN

USE ENTIRE CONTENTS OF A PRODUCT BEFORE DISPOSING THE CONTAINER.

FOLLOW MANUFACTURER'S RECOMMENDATIONS FOR PROPER USE AND DISPOSAL.

BY THE MANUFACTURER.

GENERAL CONTRACTOR CERTIFICATION

I CERTIFY UNDER PENALTY OF LAW THAT I UNDERSTAND THE TERMS AND CONDITIONS OF THE NATIONAL POLLUTANT DISCHARGE ELIMINATION SYSTEM (NPDES) GENERAL PERMIT THAT AUTHORIZES STORM WATER DISCHARGES ASSOCIATED WITH CONSTRUCTION ACTIVITY FROM THE CONSTRUCTION SITE IDENTIFIED AS PART OF THIS CERTIFICATION.

	COMPANY:
SIGNED:	
	ADDRESS:
TITLE:	
	TELEPHONE:
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OWNER CERTIFICATION

I CERTIFY UNDER PENALTY OF LAW THAT THIS DOCUMENT AND ALL ATTACHMENTS WERE PREPARED UNDER MY DIRECTION OR SUPERVISION IN ACCORDANCE WITH A SYSTEM DESIGNED TO ASSURE THAT QUALIFIED PERSONNEL PROPERLY GATHERED AND EVALUATED THE INFORMATION SUBMITTED. BASED ON MY INQUIRY OF THE PERSON OR PERSONS WHO MANAGE THE SYSTEM, OR THOSE PERSONS DIRECTLY RESPONSIBLE FOR GATHERING THE INFORMATION, THE INFORMATION SUBMITTED IS, TO THE BEST OF MY KNOWLEDGE AND BELIEF, TRUE, ACCURATE, AND COMPLETE, I AM AWARE THAT THERE ARE SIGNIFICANT PENALTIES FOR SUBMITTING FALSE INFORMATION, INCLUDING THE POSSIBILITY OF FINE AND IMPRISONMENT FOR KNOWING VIOLATIONS.

OWNER : (SIGNED)	DATE
OWNER . (DIGITED	,	
OWNER: (NAME)		
OWNER. (INITIAL)		
PHONE NUMBER:		

NARRATIVE- SEQUENCE OF CONSTRUCTION (STORM WATER MANAGEMENT) ACTIVITIES:

ESTIMATED BEGINNING CONSTRUCTION DATE: SEPTEMBER 13, 2010

- 1. BEGIN CONSTRUCTION/MOBILIZATION (5 DAYS)
- 2. INSTALL INITIAL STORMWATER POLLUTION PREVENTIONS (SWPP) MEASURES AS INDICATED ON SWPP PLAN (7 DAYS)
- 3. CLEAR AND GRUB 7 DAYS
- 4. SITE GRADING 30 DAYS

AREAS AND VEHICLE MAINTENANCE AREAS SHALL BE CONSTRUCTED BY THE

CONTRACTOR IN A MANNER TO MINIMIZE THE RUNOFF OF POLLUTANTS.

- 5. PERFORM PERIODIC INSPECTIONS OF THE SWPP STRUCTURES, PERFORM
- MAINTENANCE AND REPLACEMENTS AS NEEDED (DURATION OF CONSTRUCTION). 6. EXCAVATION FOR SITE UTILITIES AND STORM SEWER 120 DAYS
- 7. CONSTRUCTION OF SITE IMPROVEMENTS AND STORM SEWER 30 DAYS
- 8. END CONSTRUCTION FINAL STABILIZATION, DEMOBILIZATION, REMOVAL OF SWPPP CONTROLS, AND SUBMIT NOTICE OF TERMINATION.

ESTIMATED CONSTRUCTION COMPETION DATE: SEPTEMBER 13, 2011

WARNING! BEFORE YOU DIG		
CONTRACTOR SHALL FIELD LOCATE ALL EXISTING		SCHOOL DISTRICT
UNDERGROUND IMPROVEMENTS IN PROJECT AREA	NOTES:	YSLETA INDEPENDENT SCHOOL DIS

CONTRACTOR SHALL COORDINATE WITH ALL UTILITY COMPANIES PRIOR TO ANY EXCAVATION AND/OR POSSIBLE RELOCATION OF UTILITIES ENCOUNTERED

LISTING OF UTILITIES TO BE CONTACTED: EL PASO WATER UTILITIES.....1-915-594-5527 EL PASO ELECTRIC COMPANY......1-915-543-5720 TEXAS GAS SERVICE..... TIME WARNER CABLE.. T.E.S.S. (MEMBER UTILITIES).....1-800-852-3786

1. THIS PROPERTY LIES IN ZONE "X", AREAS DETERMINED TO BE OUTSIDE THE 0.2% ANUAL CHANCE FLOODPLAIN, PANEL # 480214-0048 C, DATED FEBRUARY 16, 2006.

◆ BENCHMARK:	
CITY MONUMENT AT P.I. IN F	FRONT
OF 433 RIO ARRIBA DRIVE.	
ELEVATION: 3664.67	

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325 SIMS DRIVE 79925

INDEPENDENT SCHOOL DISTRICT

CONSULTING COMPANY 1790 LEE TREVINO DRIVE SUITE 503 EL PASO, TEXAS 79936 TEL (915) 633-6422

ACTIVITIES	DATE	SIGNATURE

CONSTRUCTION ACTIVITIES LOG


INSPECTION AND MAINTENANCE REPORT

I CERTIFY UNDER PENALTY OF LAW THAT THIS DOCUMENT AND ALL ATTACHMENTS WERE PREPARED UNDER MY DIRECTION OR SUPERVISION IN ACCORDANCE WITH A SYSTEM TO ASSURE THAT QUALIFIED PERSONNEL PROPERLY GATHERED AND EVALUATED THE INFORMATION SUBMITTED. BASED ON MY INQUIRY OF THE PERSON OR PERSONS WHO MANAGE THE SYSTEM, OR THOSE PERSONS DIRECTLY RESPONSIBLE FOR GATHERING THE INFORMATION, THE INFORMATION SUBMITTED IS, TO THE BEST OF MY KNOWLEDGE AND BELIEF, TRUE, ACCURATE, AND COMPLETE. I AM AWARE THAT THERE ARE SIGNIFICANT PENALTIES FOR SUBMITTING FALSE INFORMATION, INCLUDING THE POSSIBILITY OF FINE AND IMPRISONMENT FOR KNOWN VIOLATIONS

SIGNED: DATE:
SWPPP COORDINATOR NAME:PHONE NUMBER:
LOG OF ACTIVITIES AVAILABLE: SWPPP COORDINATOR. INSPECTION LOG AVAILABLE: SWPPP COORDINATOR SCHEDULE OF ACTIVITIES AVAILABLE: SWPPP COORDINATOR
SITE DESCRIPTION: RESIDENTIAL SUBDIVISION THE EXISTING SITE IS PARTIALLY DEVELOPED. THERE ARE NO SURFACE WATERS ON THE SITE ITSELF OR ADJACENT TO THE SITE. THE SITE DISTURBANCE AREA IS 4.3846 ACR
THE SITE MAP SHOWS THE PROPERTY BOUNDARIES WITH THE PROPOSED LOCATION OF THE ROADWAY, LOTS, AND RETENTION BASINS. THIS SITE WILL BE GRADED, ROADWAY PAVED AND PONDING AREAS CONSTRUCTED. THE GRADED STREET WILL DRAIN TO THE GRADED LOTS VIA SURFACE DRAINAGE WHICH WILL CONDUCT THE STORM RUNOFF TOWARDS THE RETENTION BASINS.
INTERIM STABILIZATION MEASURES ARE AS FOLLOWS: PERIMETER, TEMPORARY EARTHEN BERMS, TEMPORARY STABILIZED CONSTRUCTION SITE EXIT.
FINAL STABILIZATION WILL BE PERFORMED BY THE HOME BUILDERS WHICH WILL CONSTRUCT A SINGLE BUILDING ON EACH LOT AND PLACE LANDSCAPING ON EXPOSED SURFACES.
THE RECEIVING WATERS ARE ON-SITE PONDING AREA AT EACH LOT
STORM WATER SAMPLING DATA IS NOT AVAILABLE FOR THIS SITE.
NO CONCRETE OR BATCH PLANTS ON THIS SITE.
NO APPARENT ENDANGERED SPECIES ON SITE. NO HISTORIC PROPERTIES ON SITE.
STORM WATER CONTAMINANTS ON SITE THE FOLLOWING ARE THE POTENTIAL STORM WATER POLLUTANTS (CHECKED ITEMS ONLY): CLEANING SOLVENTS EQUIP. CLEANING WASTEWATER ASPHALT X HYDRAULIC OIL/FLUIDS X CONCRETE X GASOLINE X PAINTS DIESEL FUEL X CURING COMPOUNDS X ANTIFREEZE/COOLANT X
THE CONTAINMENT AREA FOR THESE ITEMS IS LOCATED: AS SHOWN ON PLAN
THE STAGING AREA FOR THIS SITE IS LOCATED: AS SHOWN ON PLAN
THE PORTABLE TOILET FOR THIS SITE IS LOCATED: AS SHOWN ON PLAN
NON STORM WATER DISCHARGES ON SITE (CHECKED ITEMS ONLY). FIRE HYDRANT FLUSHING X WATER LINE FLUSHING WATER X VEHICLE WASH WATER LANDSCAPE IRRIGATION X DUST CONTROL WATER X PAVEMENT WASH WATERS
ALL STAGING AREAS, PORTABLE TOILETS AND POLLUTANT AREAS WILL INCORPORATE SECONDARY

CONTAINMENT MEASURES SUCH AS BERMS OR SEDIMENT TRAPS/BARRIERS.



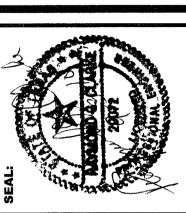

STORM WATER **POLLUTION PREVENTION PLAN NOTES**

	JUNE 2010
ł	SCALE:
I	AS SHOWN
	JOB NO. :
ŀ	SHEET NO .

SHT. 8 OF 8

VALLE-ESCONDIDO-POL-NOTES.DWG ORIG. DATE: JUNE 01, 2010