

PLANS FOR CONSTRUCTION OF

REDD ROAD ESTATES Subdivision

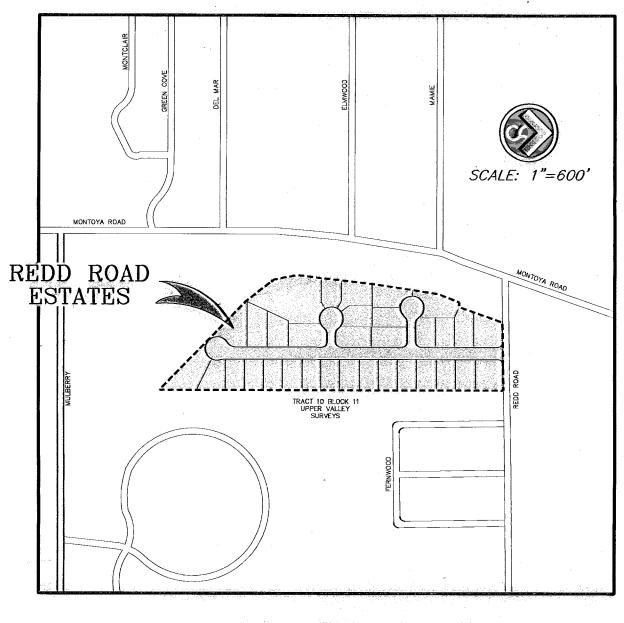

VICINITY MAP

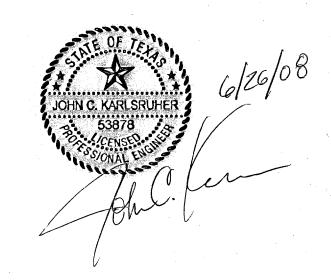

DRAWING INDEX


SHEET NO. DRAWING TITLE 3 -----DRAINAGE PLAN 4 -----GRADING PLAN ----CROSS SECTIONS ---- & PROFILE ---- DRUMMER BOY & GILS MAGIC COURT PLAN & PROFILE 10,11 -----STANDARD DETAILS 12 ------ILLUMINATION PLAN 13,14 -----STORM WATER POLLUTION PREVENTION PLAN

RECORD DRAWING




1845 Northwestern Dr. Ste C El Paso, Texas 79912 tel [915] 877.4155 fax [915] 877.4334

FILE No. 5044a

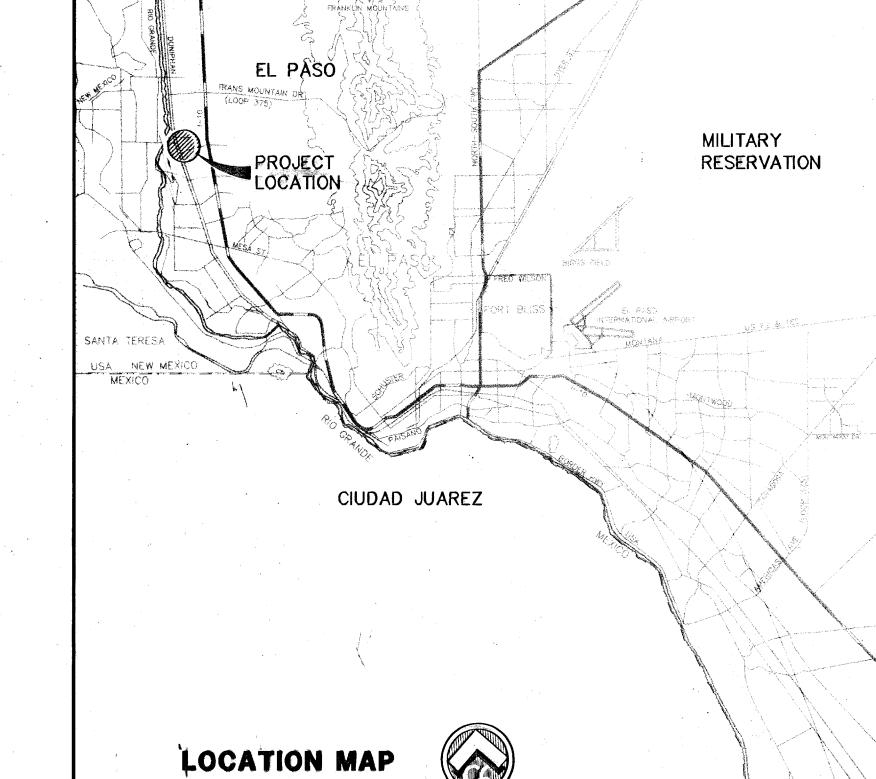

1" = 10,000'

BEING ALL OF TRACTS 21B, 21D, 21B1A AND 21B1B, BLOCK 6, UPPER VALLEY SURVEYS, CITY OF EL PASO, EL PASO COUNTY, TEXAS. CONTAINING 12.333 ± ACRES

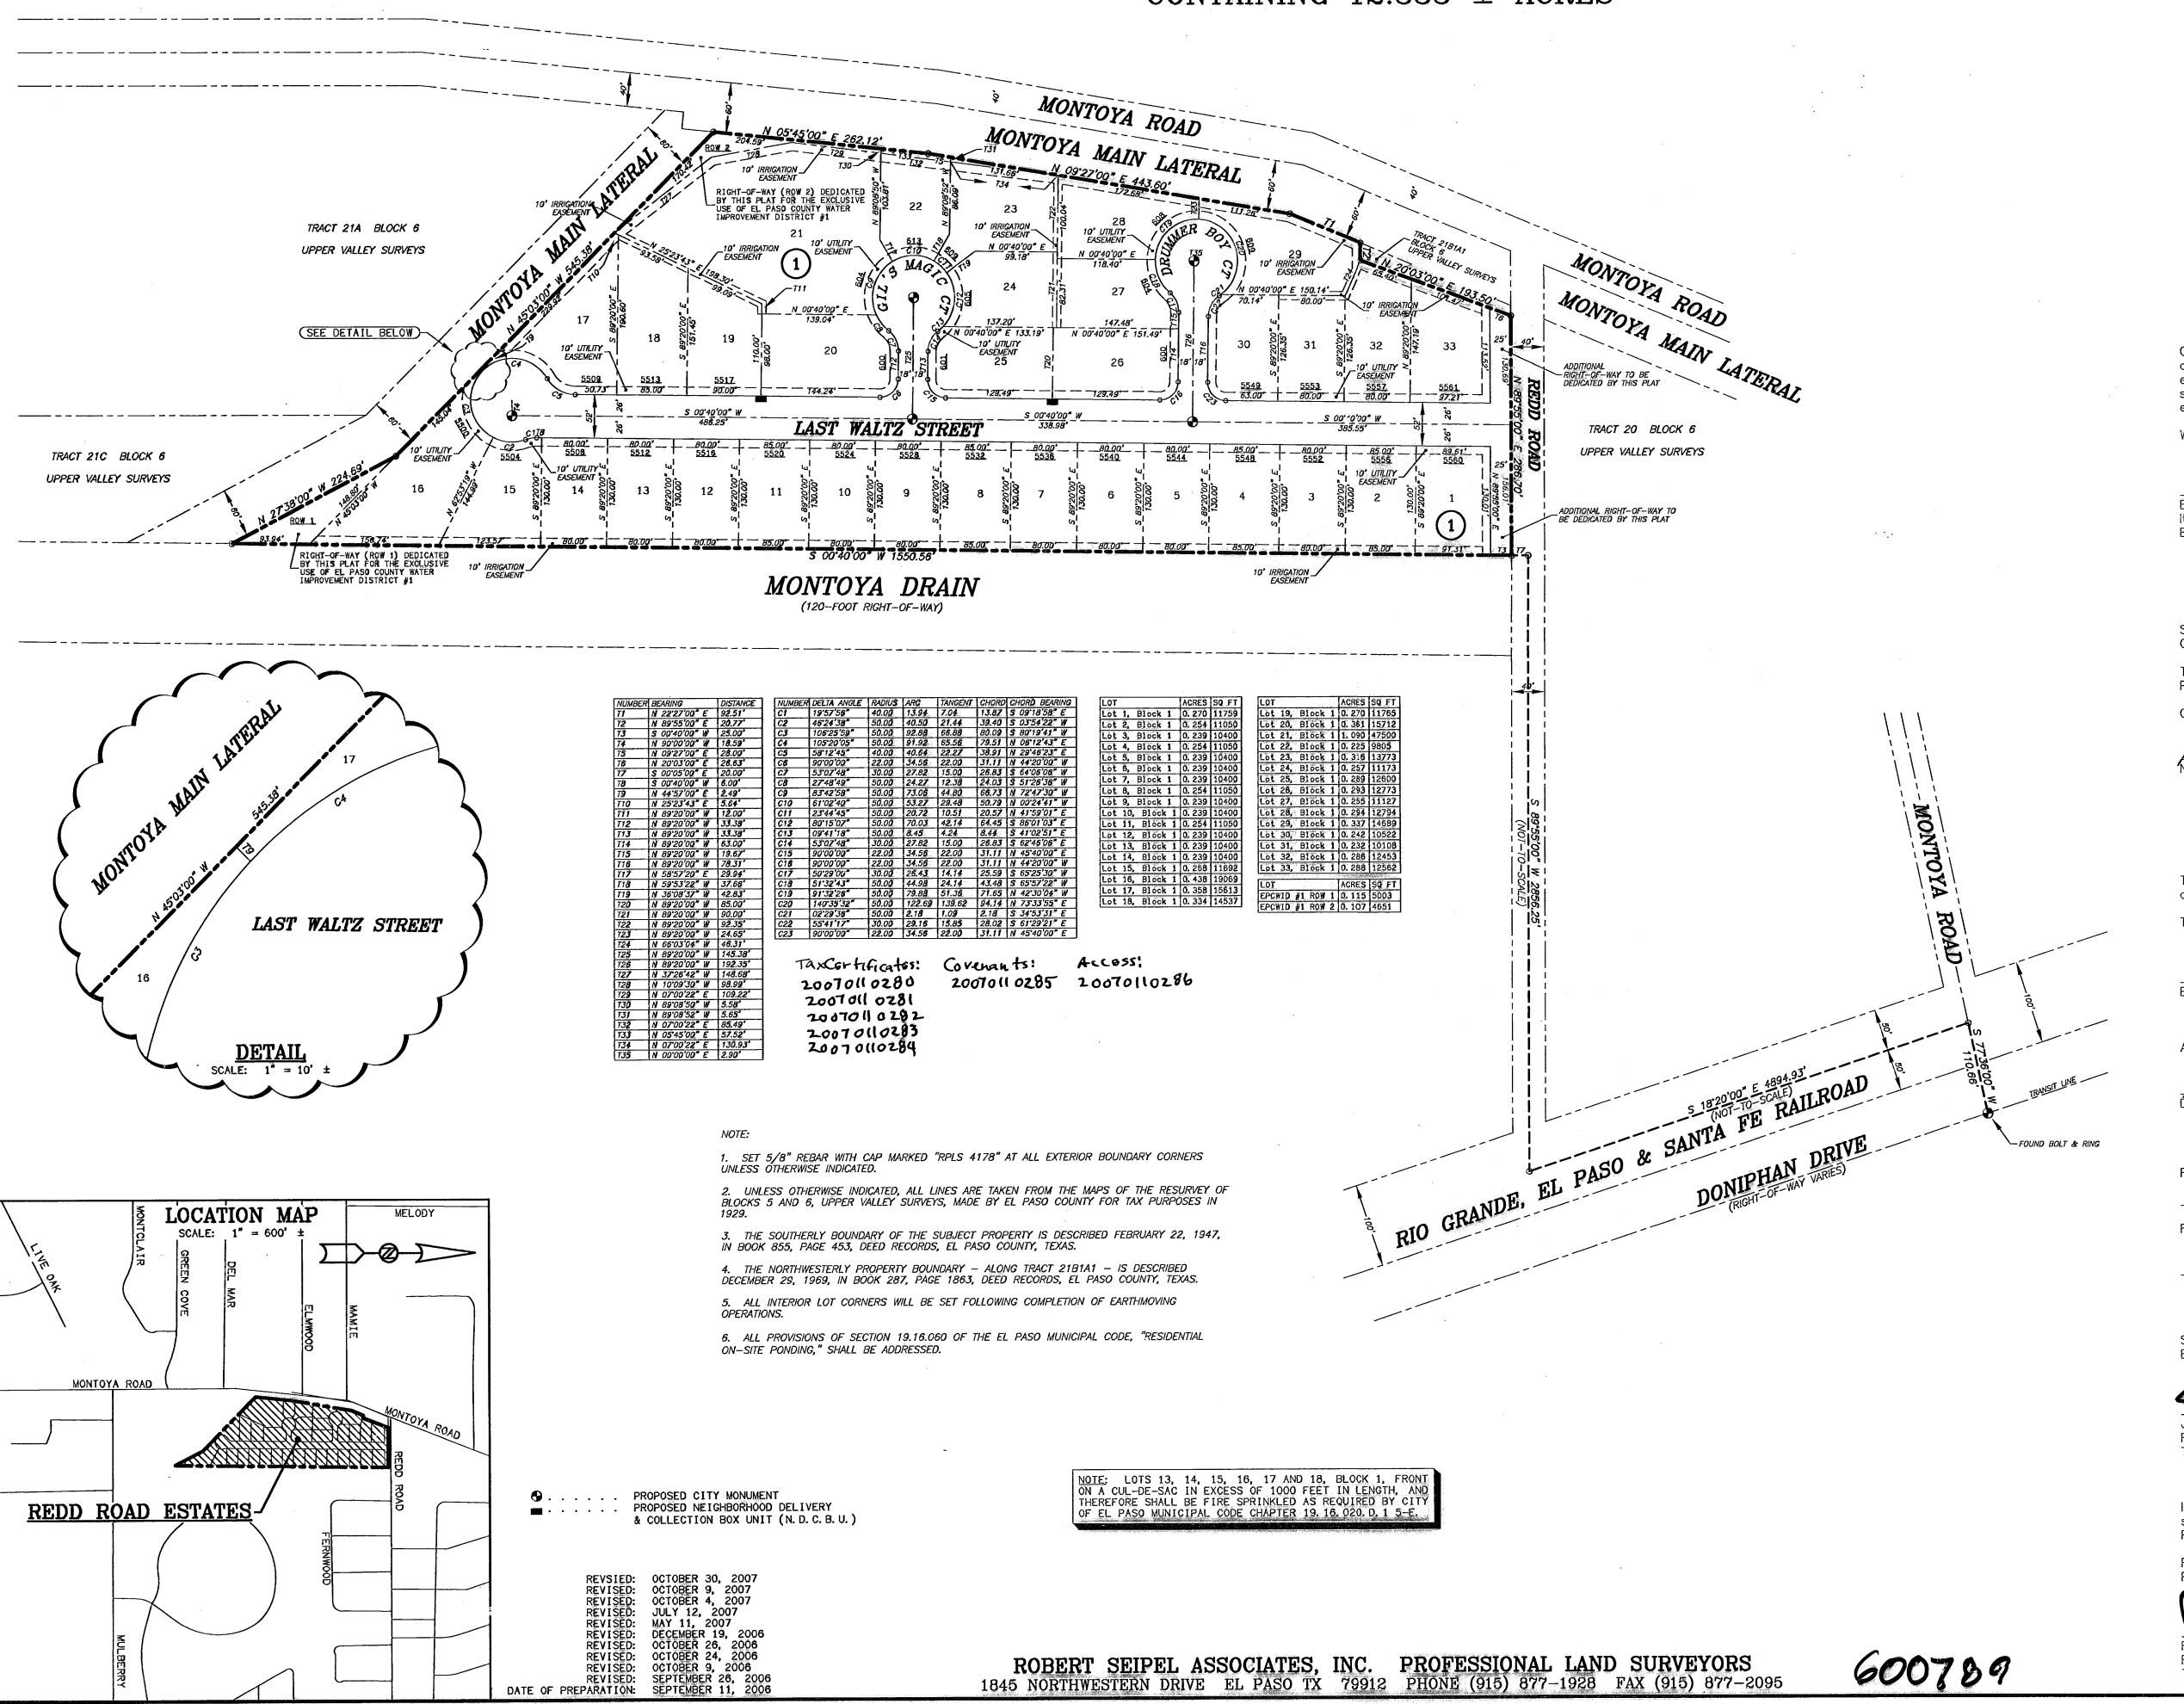

DEDICATION

Canutillo Heights Estates, LP, owners of this land, do hereby present this plat and dedicate to the use of the public the streets, drives, rights—of—way, and utility easements as hereon laid down and designated, including easements for overhang of service wires, conduits and pipes for underground utilities, the right to ingress and egress for service and construction, and the right to trim interfering trees and shrubs.

Witness my signature this 7th day of November 2007



ACKNOWLEDGMENT

STATE OF TEXAS

This instrument was acknowledged before me on President of Canutillo Heights Estates, LP.



/3/04/208 My Commission Expires

CITY PLAN COMMISSION

This subdivision is hereby approved as to the platting and as to the condition of the dedication in accordance with Chapter 212 of the Local Government Code of

Development Services Director

FILING

Filed and recorded in the office of the County Clerk of El Paso County, Texas, this ___ 2007, in Volume ____, Page ____,

Subdivision improvement plans prepared by and under the supervision of CSA Consulting

Registered Professional Engineer Texas License No. 53878


I hereby certify that this plat represents an on—the—ground survey made under my supervision in compliance with current Texas Board of Professional Land Surveying Professional and Technical Standards.

Robert Seipel Associates, Inc. Professional Land Surveyors





Texas License No. 4178



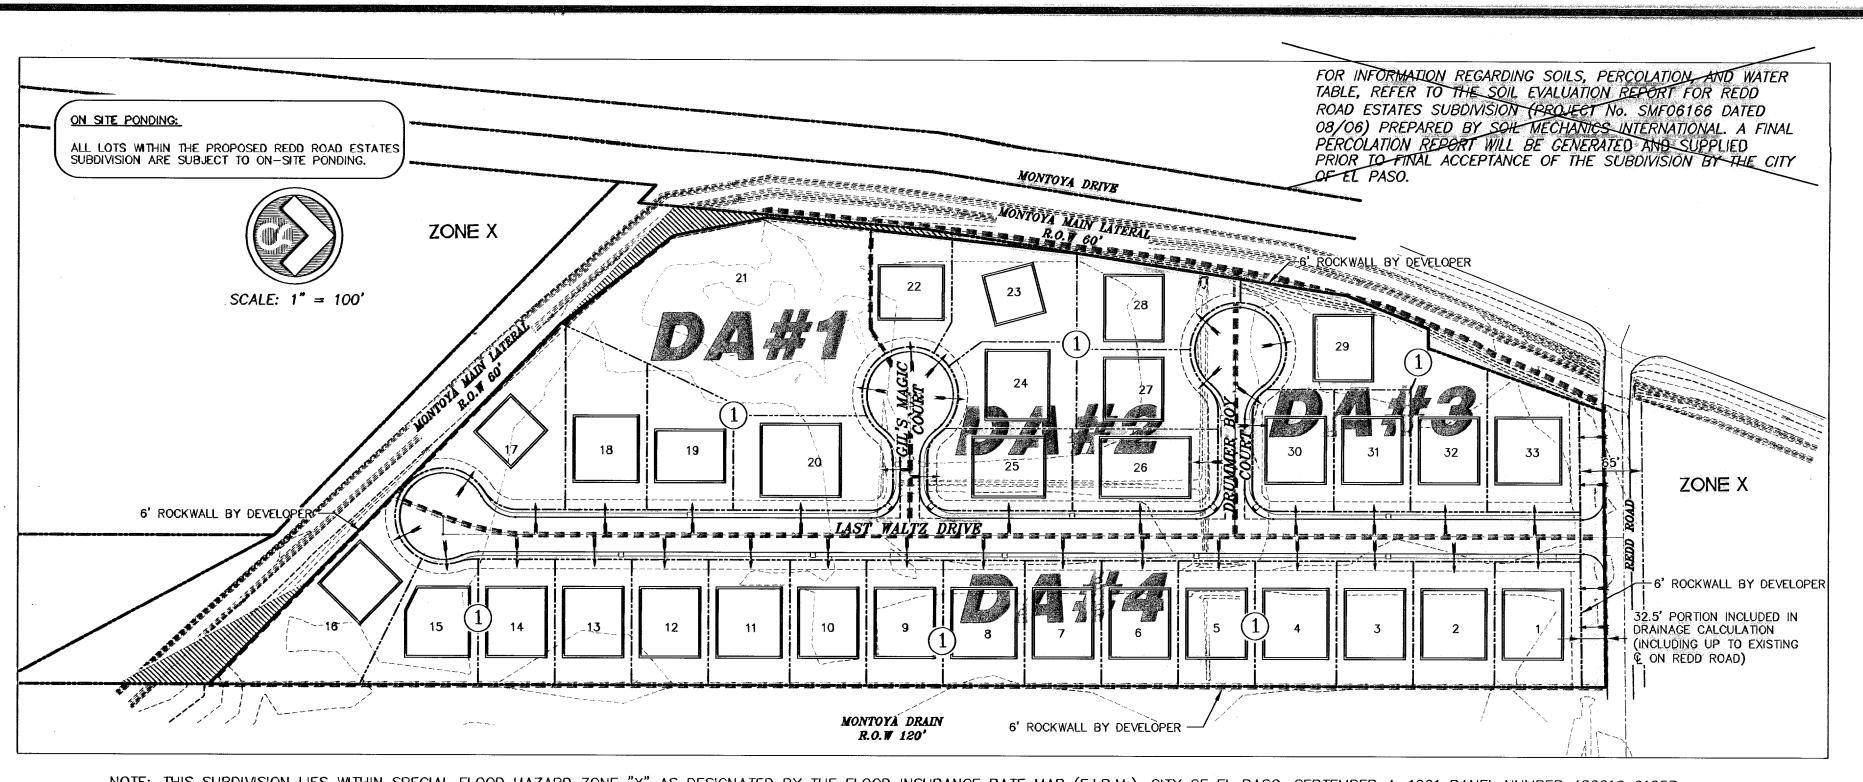

NOTE: THIS SUBDIVISION LIES WITHIN SPECIAL FLOOD HAZARD ZONE "X" AS DESIGNATED BY THE FLOOD INSURANCE RATE MAP (F.I.R.M.), CITY OF EL PASO, SEPTEMBER 4, 1991 PANEL NUMBER 480212 0125B.

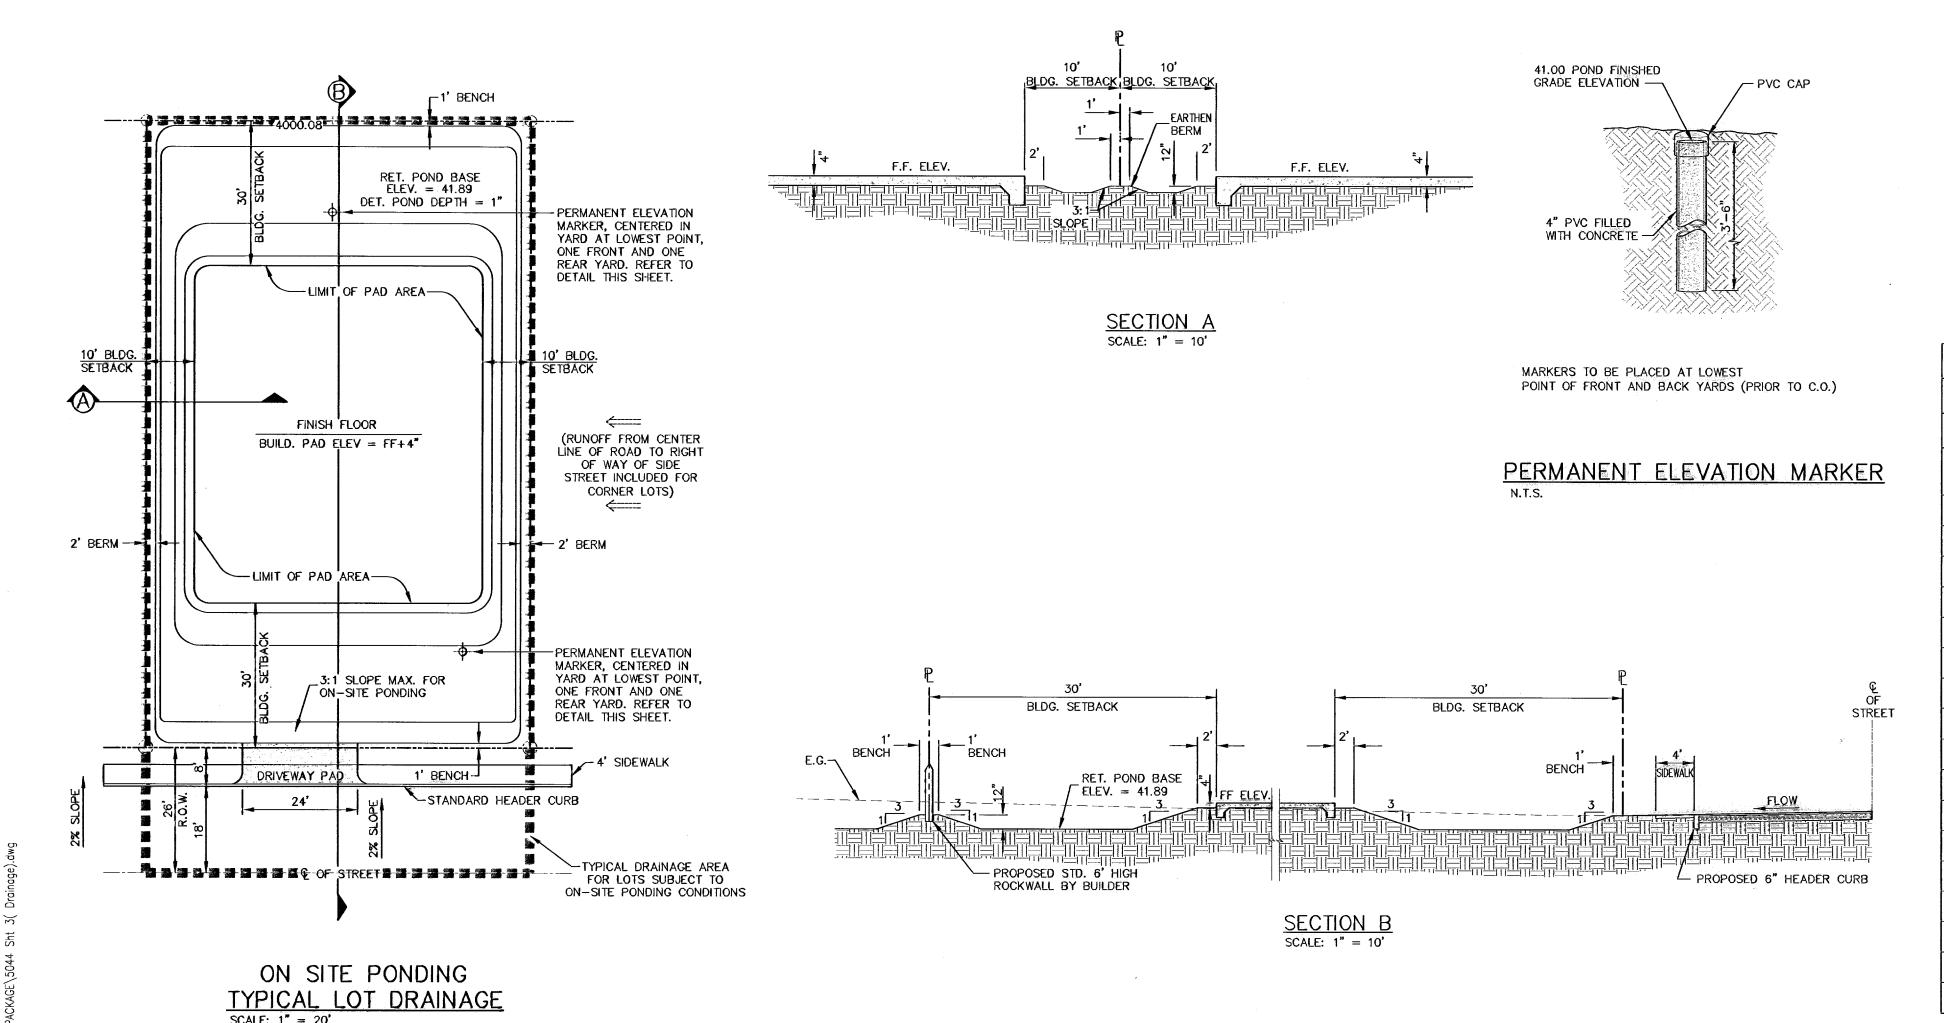

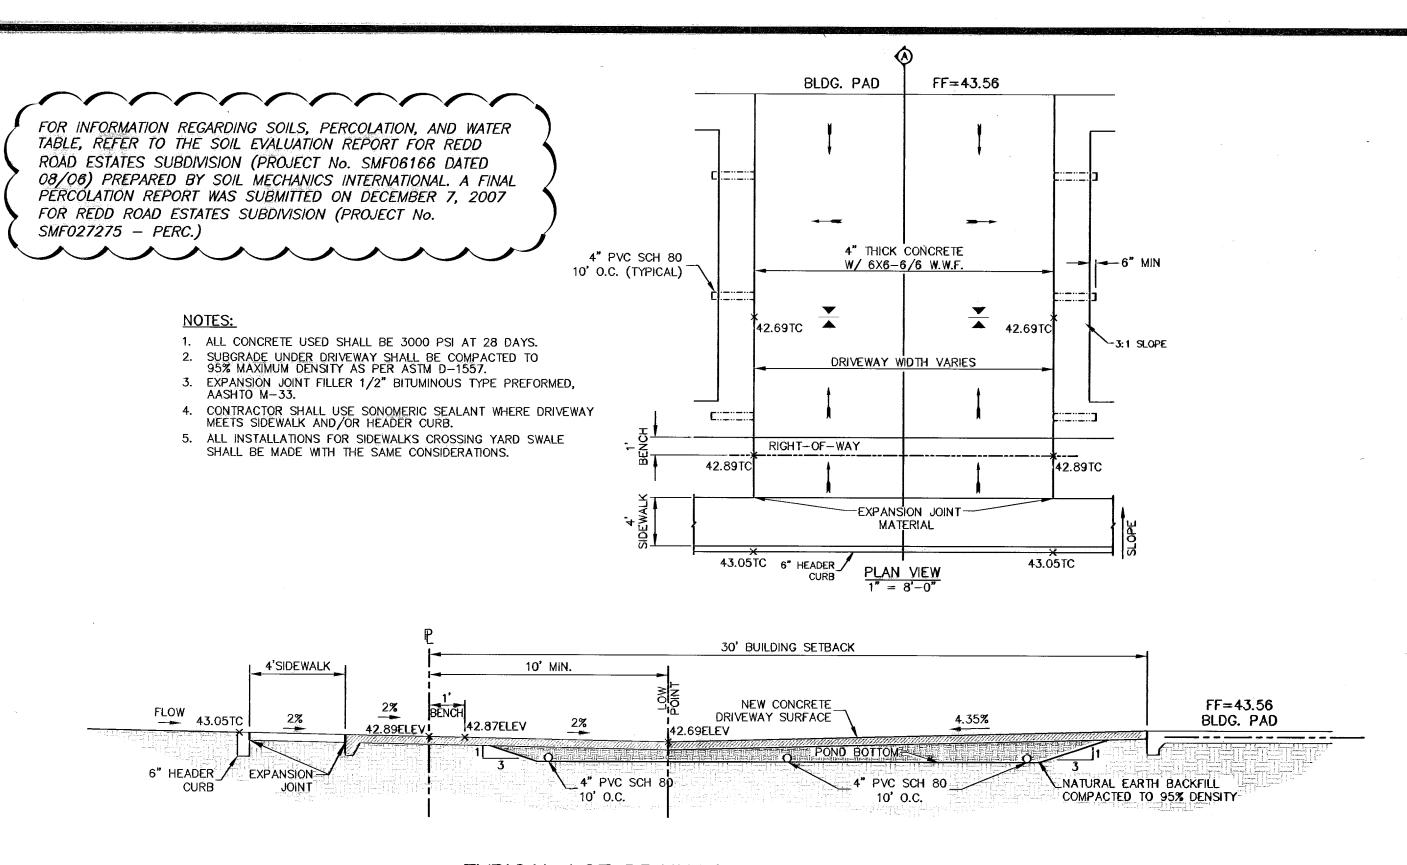

TYPICAL LOT DRAINAGE WITH DRIVEWAY

COMPUTA	COMPUTATIONS BASED ON RATIONAL FORMULA Q=CIA							
	100 YEAR STORM FREQUENCY							
WATERSHED AREA No.	AR EA ACRES	TIME OF CONCENTRATION MIN.	COEFFICIENT	INTENSITY INCHES/HOUR	DISCHARGE (Q) cfs			
DA #1	2.91	10.0	0.60	5.14	8.97			
DA#2	2.48	10.0	0.60	5.14	7.65			
DA#3	1.92	10.0	0.60	5.14	5.92			
DA #4	5.01	10.0	0.60	5.14	15.45			

LOTS WITH ON-SITE PONDING

COMPUTATIONS BASED ON RATIONAL FORMULA ARC/12 100 YEAR STORM FREQUENCY

C = 0.6, R = 4

LOT/BLOCK NUMBER	AREA (SQUARE FEET)	AREA (ACRES)	Q EXP (ACRE FEET)	Q CAP (ACRE FEET)	HW ELEV	LOT/BLOCK NUMBER	AREA (SQUARE FEET)	AREA (ACRES)	Q EXP (ACRE FEET)	Q CAP (ACRE FEET)	ELEV HW
* 1/1	19101.43	0.44	0.088	0.2550	42.24	18/1	1669 2 .9 6	0.38	0.076	0.3161	42.13
2/1	13206.64	0.30	0.060	0.1183	42.56	19/1	14051.24	0.32	0.064	0.2549	42.14
3/1	12426.60	0.29	0.058	0.1000	42.56	20/1	22791.21	0.52	0.104	0.3437	42.19
4/1	13206.64	0.30	0.060	0.1188	42.56	21/1	49.738.83	1.14	0.228	0.5608	42.19
5/1	12426.60	0.29	0.058	0.1135	42.56	22/1	11082.57	0.25	0.050	0.2117	42.13
6/1	12426.60	0.29	0.058	0.1124	42.56	23/1	14237.28	0.33	0.066	0.2989	42.11
7/1	12426.60	0.29	0.058	0.1124	42.56	24/1	13494.13	["] 0.31	0.062	0.2417	42.15
8/1	13206.64	0.30	0.060	0.1197	42.56	25/1	18759.47	0.43	0.086	0.2739	42.20
9/1	12426.60	0.29	0.058	0.1124	42 .5 6	26/1	18759.47	0.43	0.086	0.2775	42.20
10/1	12426.60	0.29	0.058	0.1129	42.56	27/1	13207.52	0.30	0.060	0.2406	42.14
11/1	13206.64	0.30	0.060	0.1185	42.56	28/1	14641.58	0.34	0.068	0.2769	42.14
12/1	12426.60	0.29	0.058	0.1135	42.56	29/1	18493.45	0.42	0.084	0.3180	42.15
13/1	12426.60	0.29	0.058	0.1130	42.56	30/1	15638.40	0.36	0.072	0.2279	42.20
14/1	12426.60	0.29	0.058	0.1129	42.56	31/1	12134.26	0.28	0.056	0.2181	42.15
15/1	13047.09	0.30	0.060	0.1965	42.20	32/1	14478.66	0.33	0.066	0.2701	42.13
16/1	21602.94	0.49	0.098	0.4146	42.13	* 33/1	19380.83	0.44	0.088	0.2728	42.20
17/1	21596.82	0.50	0.100	0.3380	42.19		·	; , , , , , , , , , , , , , , , , , , ,			· · · · · · · · · · · · · · · · · · ·

TOTAL AREA = 537213.54 SQ. FT. = 12.33 ACRES
POND CALCULATIONS FOR RESIDENTIAL LOTS WERE FIGURED USING THE MAXIMUM ALLOWABLE BUILDING PAD AREA FOR EACH LOT. THE ACTUAL POND VOLUME WILL BE MUCH GREATER
BASED UPON ACTUAL PAD AREA UTILIZED.

* LOTS ARE DESIGNED TO ACCOMODATE HALF OF REDD ROAD RUNOFF ADJACENT TO PROPERTY.

RECORD DRAWING

BENCHMARK: CITY MONUMENT AT THE WESTERLY CENTERLINE INTERSECTION OF FERNWOOD CIRCLE AND REDD ROAD.

NO.	DATE	DESCRIPTION	BY
4	04-15-08	RECORD DRAWING	J.C.K
3	10-11-07	FINAL CITY SUBMITTAL	J.C.K
2	10-05-07	2nd CITY SUBMITTAL	J.C.K
1	09-20-07	1ST CITY SUBMITTAL	J.C.K

JOHN C. KARLSRUHER 53878 C/STEAT	This document, hard copy or readable for copyrighted and a of Services in response for the project for whi prepared. This not intended or a reuse by any extensions of suc any other project. including copyil modifying the without written from CSA CEngineers for the purpose intended of federal copy Unauthorized us material may readady or criminal
Control of the contro	

er in ne		csa design gro	ouo	
rument to the was eent is ed for on eet or		1845 Northwestern Dr. : El Paso, Texas 799' tel [915] 877.4155 fax [915] 877.4334 www.csaengineers.co	Ste C 12 5	5044 JOB NO. 09/20/07 DATE AS NOTED
reuse, /or ent,	REDD RO	AD ESTATES SUB	DIVISION	SCALE SHEET NO.
sion ig cific iolation	D	RAINAGE PLAI	N	∃ 3
law. this civil ties.	J.C.K	DRAWN BY	J.C.K	· 14

WARNING BEFORE YOU DIG CONTRACTOR SHALL

FIELD LOCATE ALL EXISTING JNDERGROUND IMPROVEMENT IN PROJECT AREA

BEFORE YOU DIG -EL PASO ELECTRIC COMPANY TEXAS GAS SERVICE **EMERGENCY HOTLINE** PUBLIC SERVICE BOARD (WATER & SEWER)

EL PASO NATURAL GAS CO.

TIME WARNER COMMUNICATIONS (CABLE)

TEXAS EXCAVATION SAFETY SYSTEM

CALL 543-5720 1-800-DIG-TESS 544-6300 562-8411/562-2003 1-800-DIG-TESS 775-7414 1-800-334-8047 1-800-344-8377

4010-


LEGEND DIRECTION OF FLOW DRAINAGE AREA BOUNDARY PROPOSED HIGH POINT PROPOSED LOW POINT PROPOSED CONTOUR


EXISTING CONTOUR

PROPOSED CITY MONUMENT 50' TRANSITION

AREAS WITH ON-SITE PONDING

EXISTING CITY MONUMENT

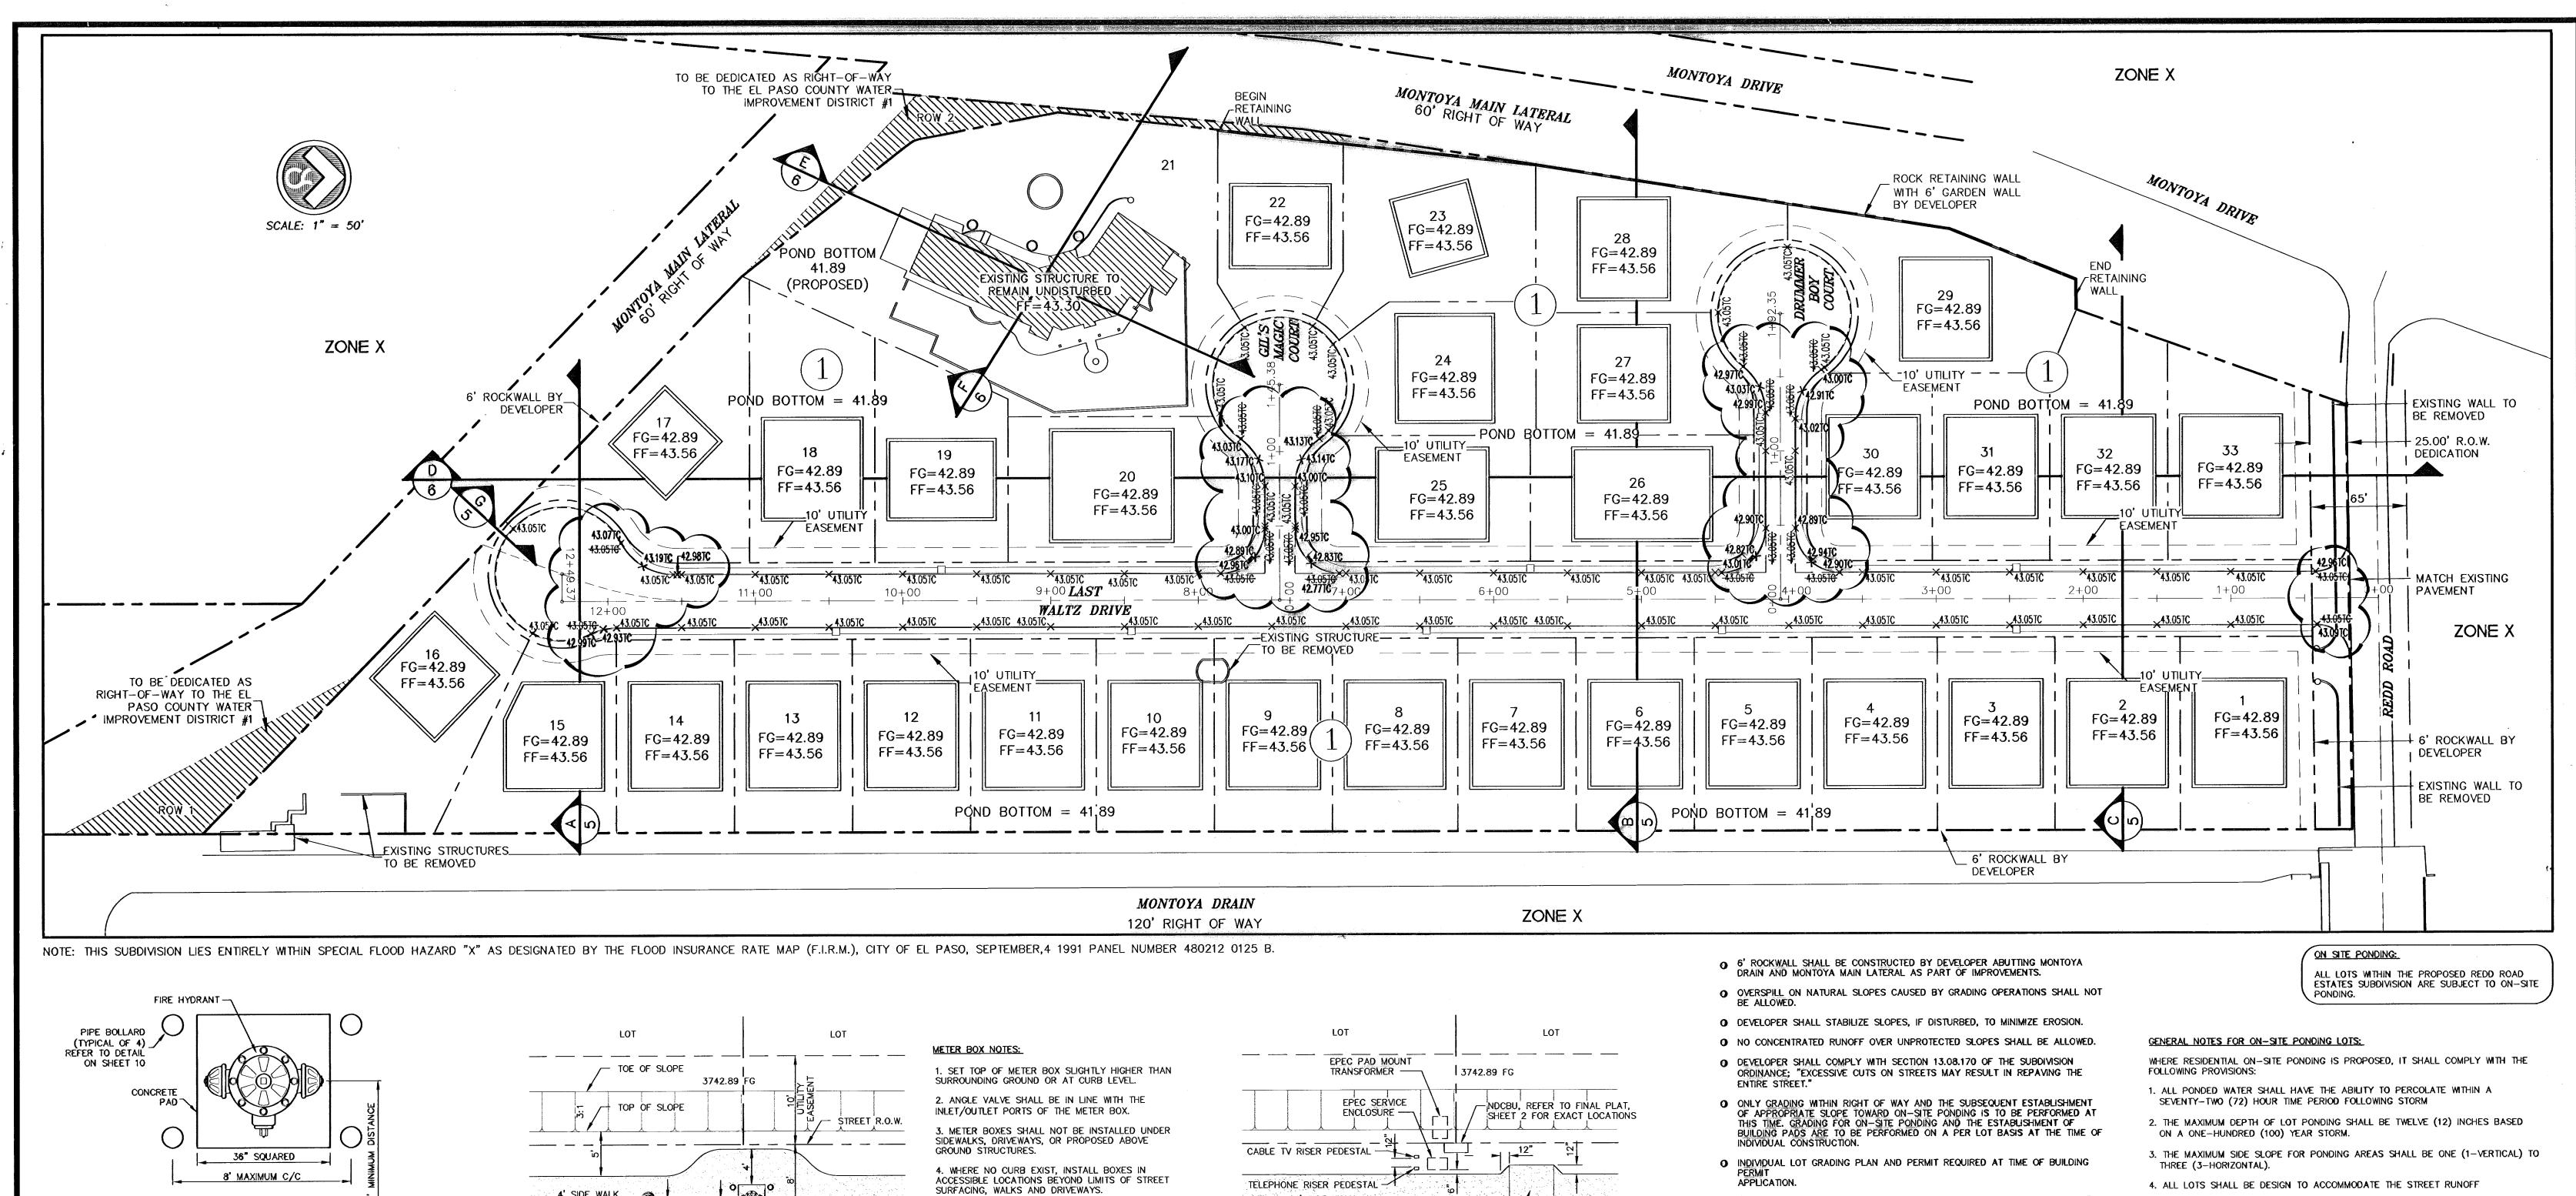

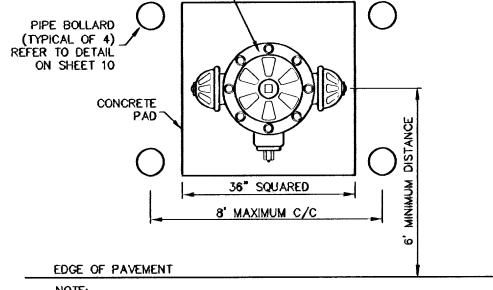

NOTE: WHERE NO CURB AND GUTTER EXIST, HYDRANT SHALL BE MOUNTED ON 3' x 3' x 6"MIN PAD, 3000 PSI CONCRETE MINIMUM, WITH 4" PIPE BOLLARDS AS SHOWN ABOVE.

HYDRANT PLAN VIEW

. LOCATIONS OF ALL UTILITIES SHOWN ON THIS PLAN ARE APPROXIMATE.

IT SHALL BE THE CONTRACTOR'S RESPONSIBILITY TO CONTACT ALL

UTILITY COMPANIES FOR THE EXACT LOCATION OF UNDERGROUND AND

OVERHEAD UTILITIES INCLUDING UTILITIES NOT SHOWN ON PLANS. THE CONTRACTOR SHALL PROTECT ALL EXISTING UNDERGROUND AND OVERHEAD

UTILITIES AND ANY UTILITIES NOT SHOWN ON THIS PLAN DURING

INSTALLATION, REMOVAL AND RELOCATION'S AS PER LOCAL UTILITY

CONSTRUCTION SHALL BE REPLACED AT THE CONTRACTOR'S EXPENSE

. CONTRACTOR IS RESPONSIBLE FOR VERIFYING ALL DIMENSIONS AND

3. ALL CONSTRUCTION TO BE COMPLETED IN ACCORDANCE WITH THE CITY


4. CONTRACTOR SHALL PERFORM ALL EARTHWORK REQUIREMENTS AS PER

ELEVATIONS ON SITE AND SHALL CONTACT THE DESIGN ENGINEER AND

REPORT ANY DISCREPANCIES, OMISSIONS AND/OR ERRORS ON PLANS

CONSTRUCTION SPECIFICATIONS. ANY UTILITIES DAMAGED DURING

CONSTRUCTION. THE CONTRACTOR WILL PERFORM ALL UTILITY

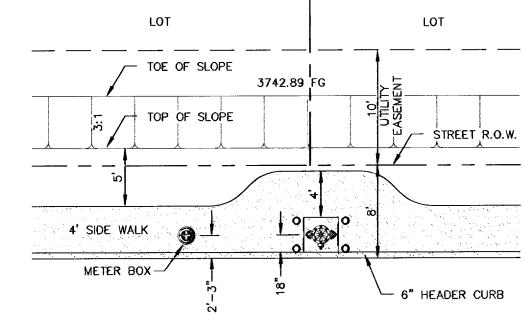

TYPICAL LOCATION OF METER BOX AND FIRE HYDRANT

FIRE HYDRANT NOTES:

1. FIRE HYDRANT SHALL BE LOCATED AT THE PROPERTY LINE COMMON TO ADJOINING LOTS.

2. A MINIMUM CLEARANCE OF 3 FT SHALL BE PROVIDED BETWEEN A FIRE HYDRANT AND A PERMANENT OBSTRUCTION (UTILITY POLE, LIGHT STANDARD, TRAFFIC SIGNAL, WHEEL CHAIR RAMP, FENCE PROTECTIVE POSTS, etc.)

4' SIDE WALK

TYPICAL LOCATION OF TRANSFORMERS, 1" = 10'

5'x5' PASSING ZONE

LOTS 13, 14, 15, 16, 17 AND 18, BLOCK 1, FRONT ON A CUL-DE-SAC IN EXCESS OF 1000 FEET IN LENGTH, AND THEREFORE SHALL BE FIRE SPRINKLED AS REQUIRED BY THE CITY OF EL PASO MUNICIPAL CODE CHAPTER 19.16.020.D.1 5-E O PRELIMINARY SOILS TEST. FINAL PERCOLATION RATE TEST, SOILS TESTS, AND WATER TABLE ELEVATION INFORMATION TO BE SUBMITTED PRIOR TO STREET ACCEPTANCE AND/OR BUILDING PERMITS.

FOR INFORMATION REGARDING SOILS, PERCOLATION, AND WATER TABLE, REFER TO THE SOIL EVALUATION REPORT FOR REDD ROAD ESTATES SUBDIVISION (PROJECT No. SMF06166 DATED 08/06) PREPARED BY SOIL MECHANICS INTERNATIONAL. A FINAL PÉRCÓLATION REPORT WAS SUBMITTED ON DECEMBER 7, 2007 FOR REDD ROAD ESTATES SUBDIVISION (PROJECT No. SMF027275 - PERC.)

MAINTENANCE NOTE:

1. SLOPE AREAS SHALL BE MAINTAINED BY PROPERTY OWNER.

- 5. A PERMANENT ELEVATION MARKERS SHALL BE PLACE PRIOR TO BUILDING OCCUPANCY. 6. FILLING OR CHANGING THE LOT, OR ALLOWING THEN LOT TO BE FILLED OR
- CHANGED TO AN ELEVATION GREATER THAN ESTABLISHED BY THE PERMANENT ELEVATION MARKER IS PROHIBITED.
- 7. THE CITY SHALL BE GRANTED PERMANENT RIGHT OF ACCESS TO INSPECT THE LOT ELEVATION AND THE PERMANENT ELEVATION MARKERS.
- 8. IMPAIRMENT OF THE RESIDENTIAL ON-SITE PONDING IS PROHIBITED.
- 9. THE OWNER IS TO RESTORE THE RESIDENTIAL ON-SITE PONDING FUNCTIONALITY OF THE LOT IN THE EVENT IT IS IMPAIRED.
- 10. A RESTRICTION THAT NO MORE 50 PERCENT OF THE AREA OF THE RESIDENTIAL LOT CONVEYED BY THE DEED MAY EVER BE COVERED BY IMPROVEMENTS OF ANY KIND, EITHER TEMPORARY OR PERMANENT, WHICH WILL SHED STORMWATER ONTO

2. OFFSITE IMPROVEMENTS SHALL BE MAINTAINED BY DEVELOPER. Final Grading Permit #06-00466 **ISSUED 12-12-06**

ALL SIDEWALKS AND ACCESSIBLE RAMPS SHALL COMPLY WITH ADA AND TAS STANDARDS AND GUIDELINES

BENCHMARK: CITY MONUMENT AT THE WESTERLY CENTERLINE INTERSECTION OF FERNWOOD CIRCLE AND REDD ROAD. ELEVATION = 3741.43 (CITY OF EL PASO DATUM)

WARNING! BEFORE YOU DIG

OF EL PASO STANDARD SPECIFICATIONS AND DETAILS.

GENERAL NOTES:

PRIOR TO COMMENCING WORK.

GEOTECHNICAL STUDY REPORT.

CONTRACTOR SHALL FIELD LOCATE ALL EXISTING JNDERGROUND IMPROVEMENT IN PROJECT AREA

BEFORE YOU DIG -EL PASO ELECTRIC COMPANY

TEXAS GAS SERVICE **EMERGENCY HOTLINE** PUBLIC SERVICE BOARD (WATER & SEWER) TIME WARNER COMMUNICATIONS (CABLE) EL PASO NATURAL GAS CO. TEXAS EXCAVATION SAFETY SYSTEM

VEGETATION.

TOWARDS THE LOTS.

PROVIDED TO CITY DATUM.

CALL 543-5720 544-6300

.5. INSTALL A TRENCH SAFETY SYSTEM FOR ALL TRENCHES EXCEEDING A

7. POSITIVE DRAINAGE SHALL BE PROVIDED BY CONTRACTOR DURING ALL

PHASES OF CONSTRUCTION AND GRADING. ALL DRAINAGE SHOULD DRAIN

8. CONTRACTOR SHALL BE RESPONSIBLE FOR THE PREPARATION AND

SUBMITTAL OF ALL PERMITTING NECESSARY FOR EARTHWORK OPERATIONS

9. NOTE TO BUILDERS: RETAINING WALLS MUST BE PROVIDED WHENEVER

THE GRADE DIFFERENTIAL BETWEEN LOT GRADES IS GREATER THAN 2.0 FEET. WALLS MUST BE DESIGNED AND CERTIFIED BY A CIVIL ENGINEER

10. EXISTING CONTOURS, PROPOSED CONTOURS AND ELEVATIONS ARE

(FOR APPROVAL) WHEN APPLYING FOR A BUILDING PERMIT.

6. SLOPES WHICH ARE TO RECEIVE FILL MUST BE CLEARED OF ALL

DEPTH OF FIVE FEET (5') AS PER OSHA STANDARDS.

AND STORM WATER POLLUTION CONTROL.

1-800-DIG-TESS 562-8411/562-2003 1-800-DIG-TESS 775-7414 1-800-334-8047 1-800-344-8377

<u>LEGEND</u> 99.35 3999.35

00.35 4000.35 09.35 4009.35 10.35 4010.35 PROPOSED HOUSE FINISH FLOOR 75.72 W/ FINISHED GRADE ELEV. SUBDIVISION FINISH GRADE ELEV. PROPOSED TOP OF CURB

√75.72TC 4010-4010-0000000

PROPOSED HIGH POINT PROPOSED LOW POINT PROPOSED CONTOUR EXISTING CONTOUR RETAINING WALL REQUIRED

1) FF ELEVATION + 4 INCHES = FG AT BUILDING PAD. 2) FG 3741.89 = ELEVATION MARKER AT POND

DATE

4 | 04-15-08 |

3 10-11-07

2 10-05-07

09-20-07

DESCRIPTION

RECORD DRAWING


FINAL CITY SUBMITTAL


2nd CITY SUBMITTAL


1ST CITY SUBMITTAL


3) PONDING DEPTH MINIMUM = 8 INCHES.


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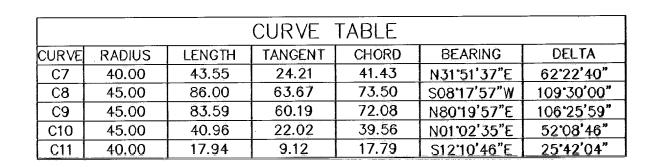


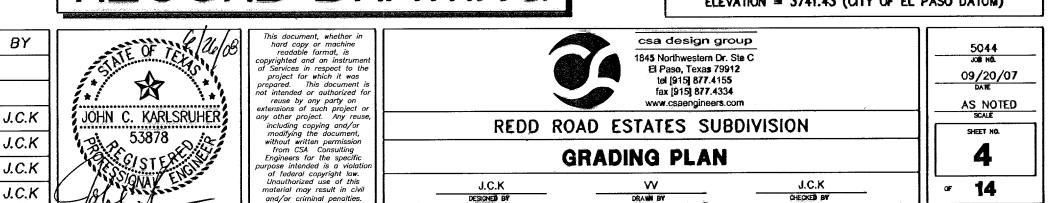

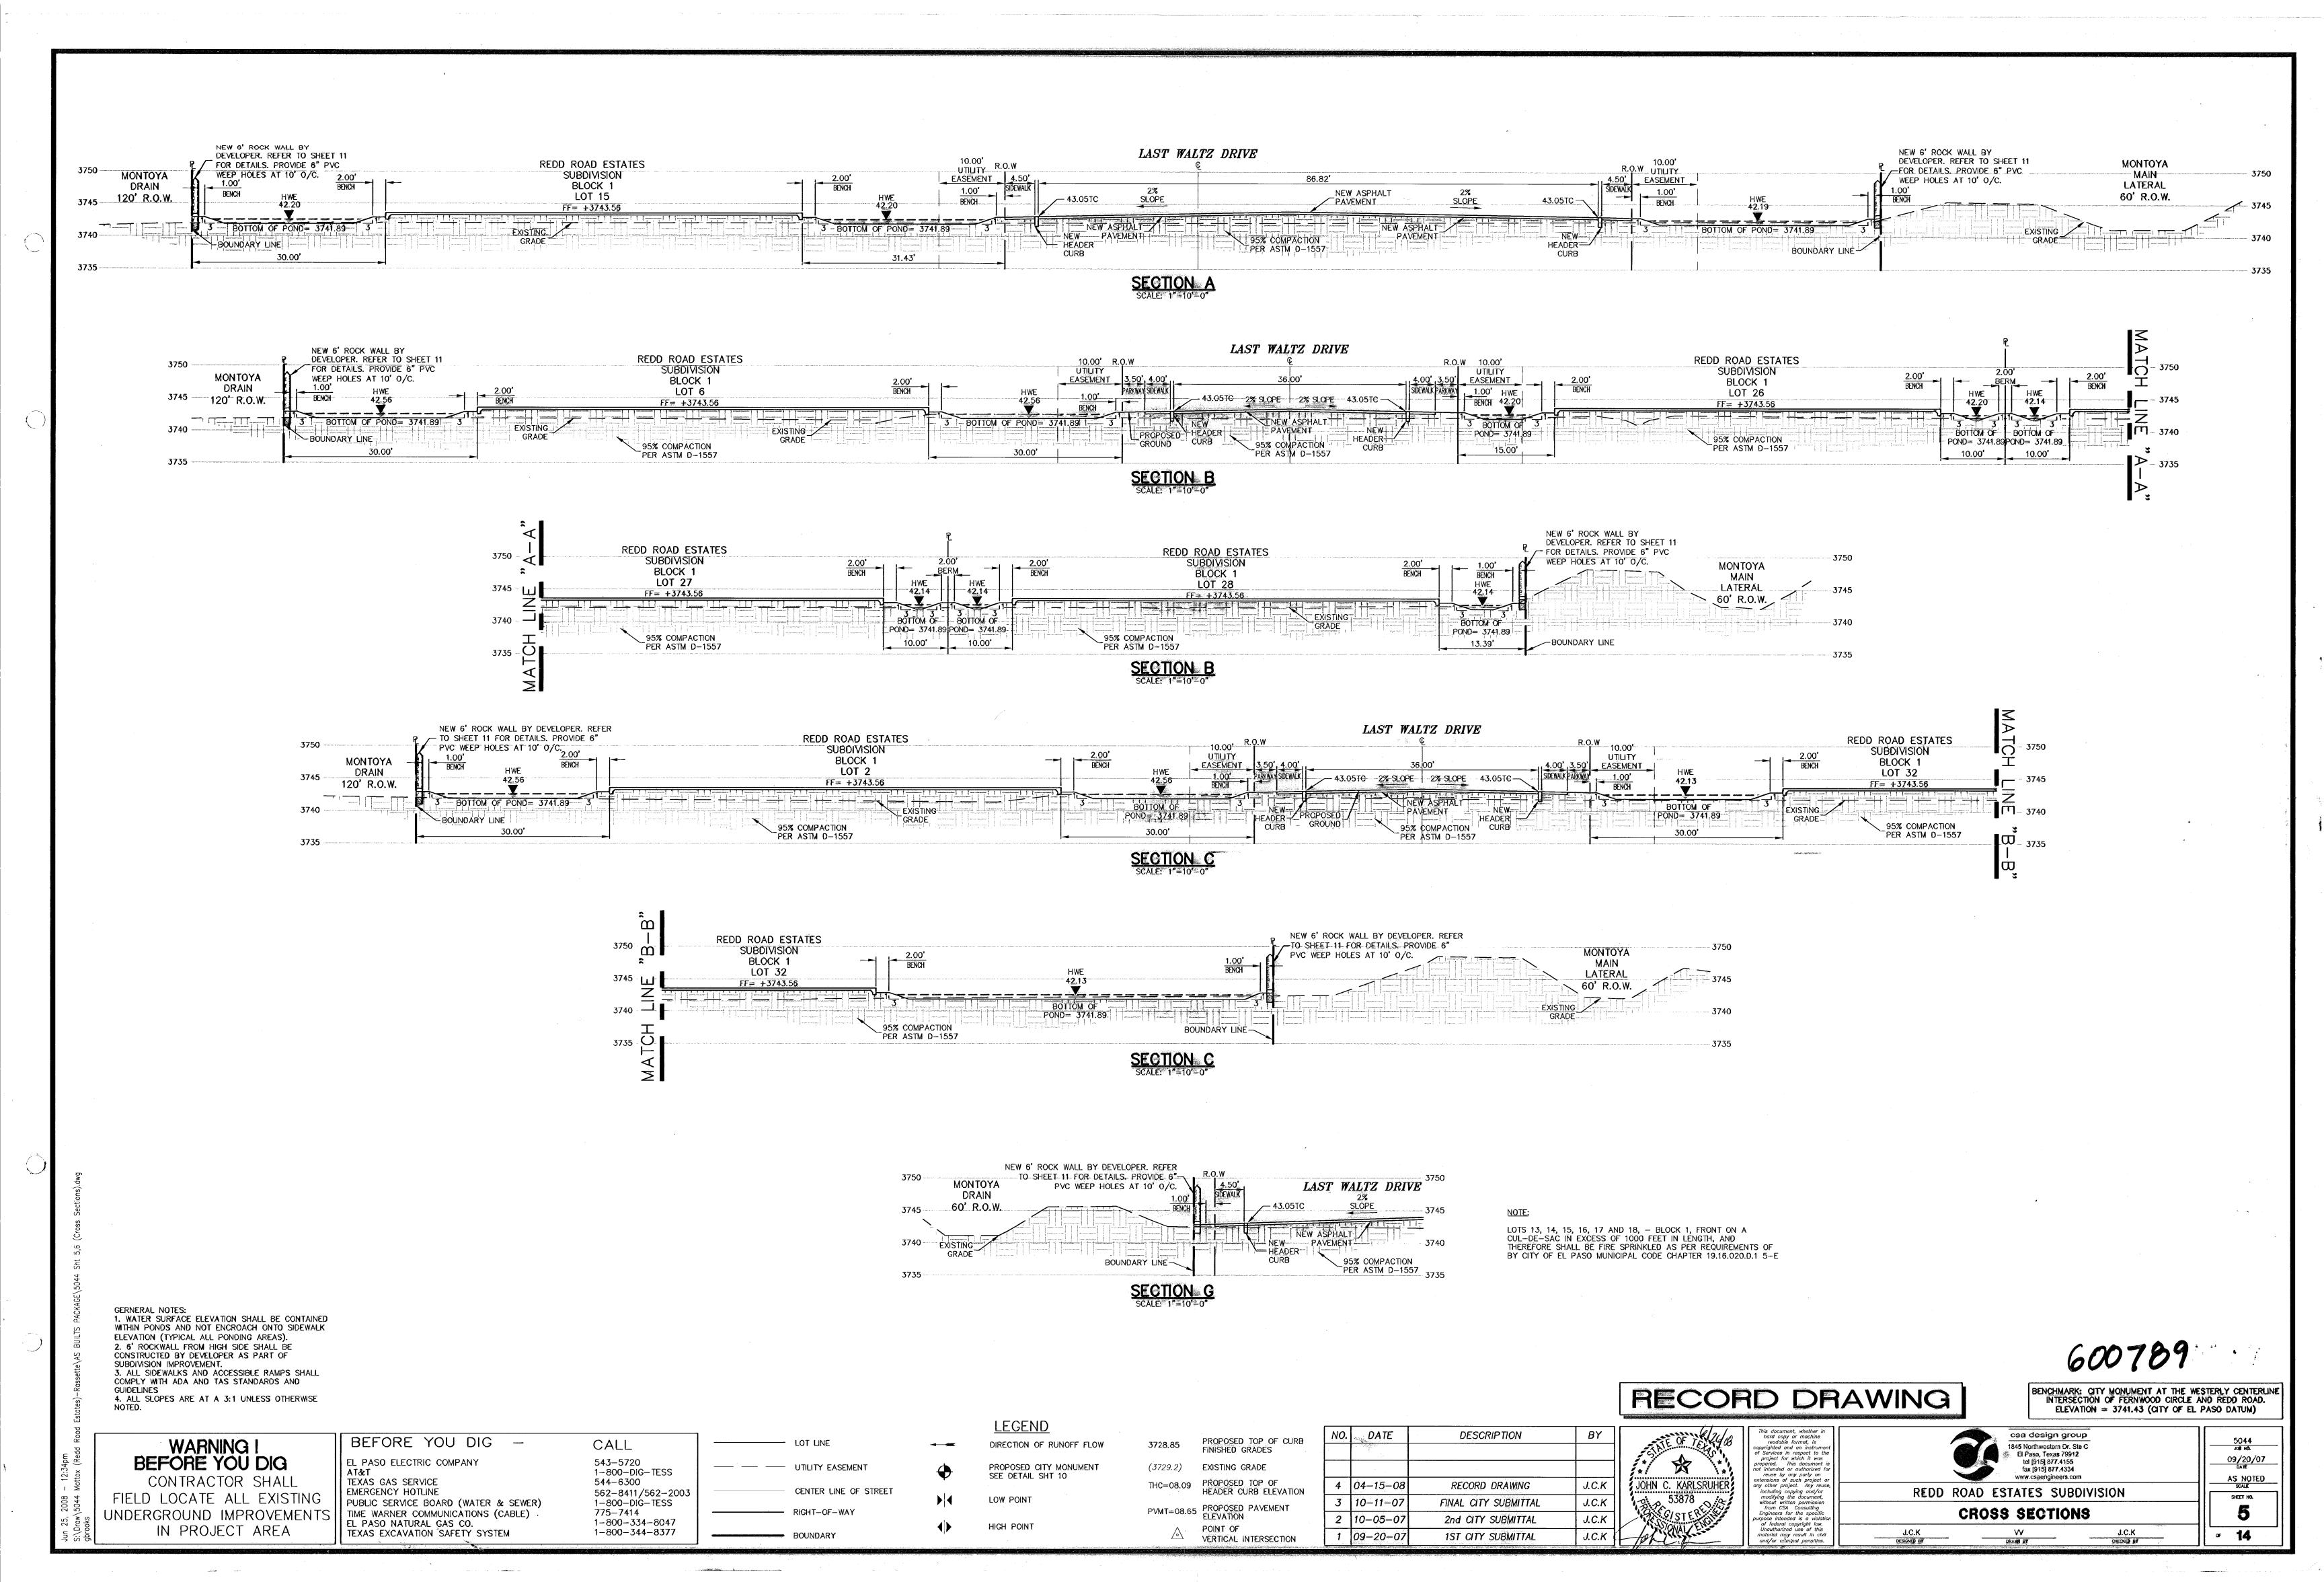


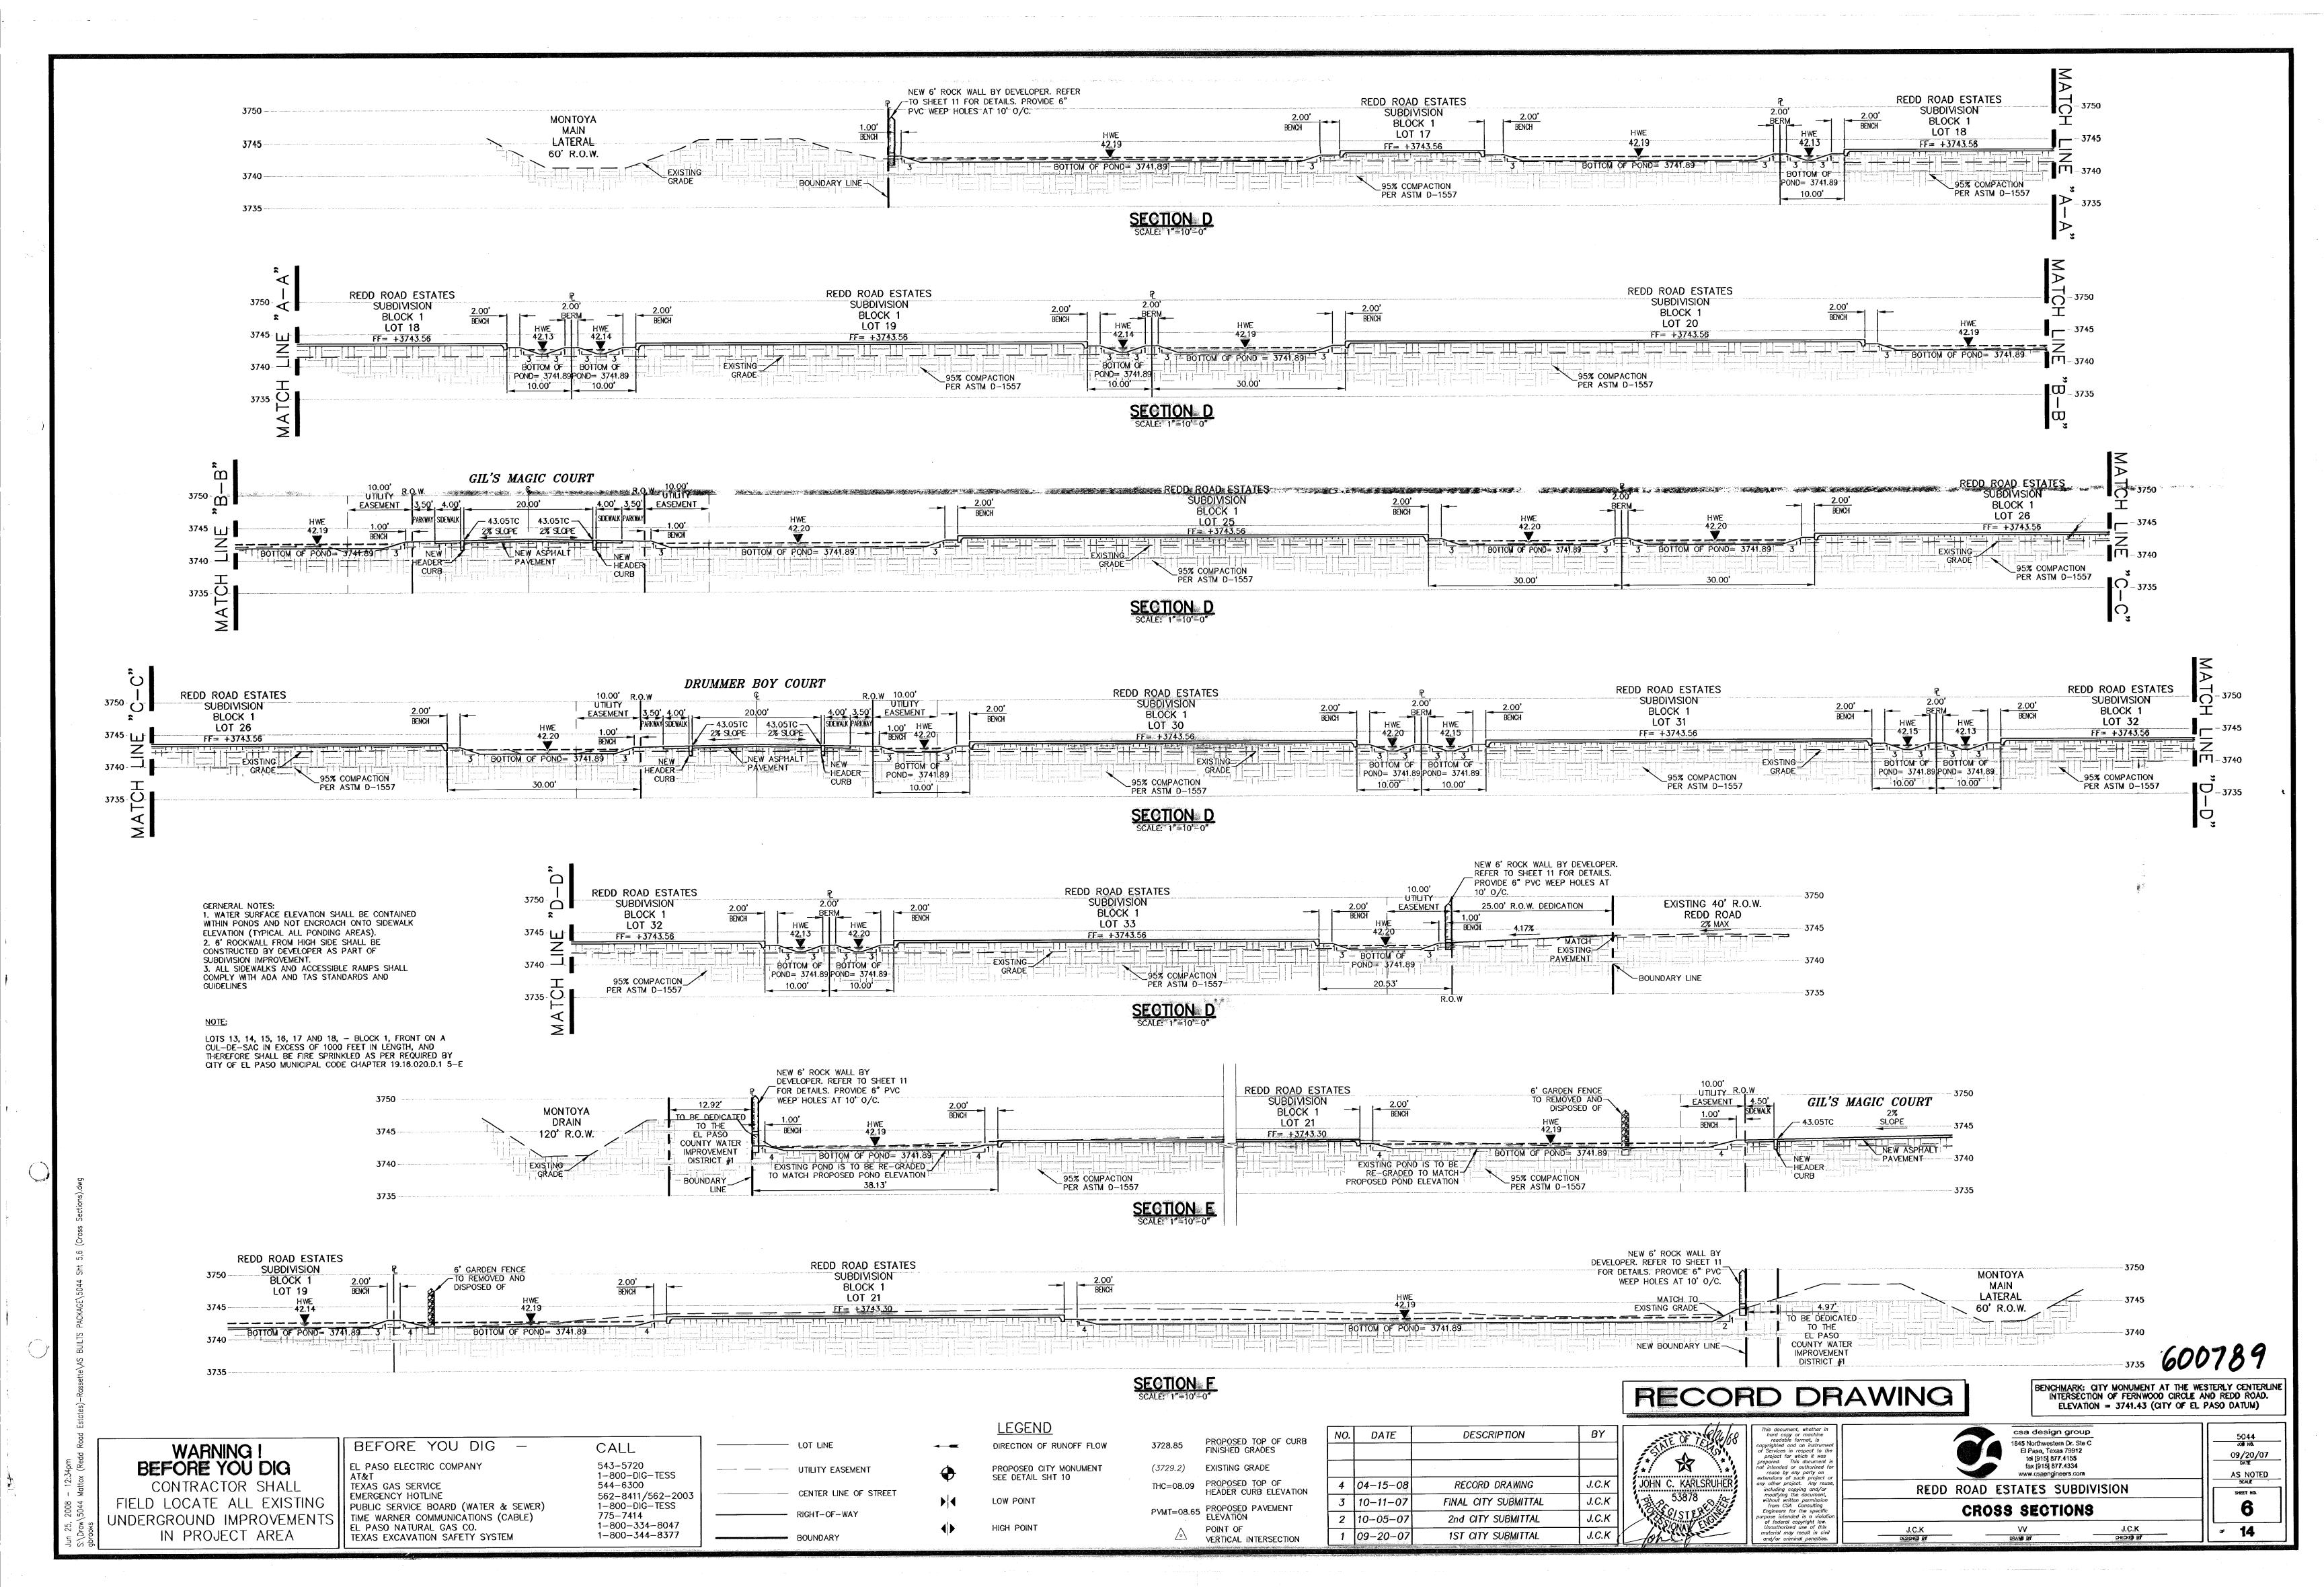

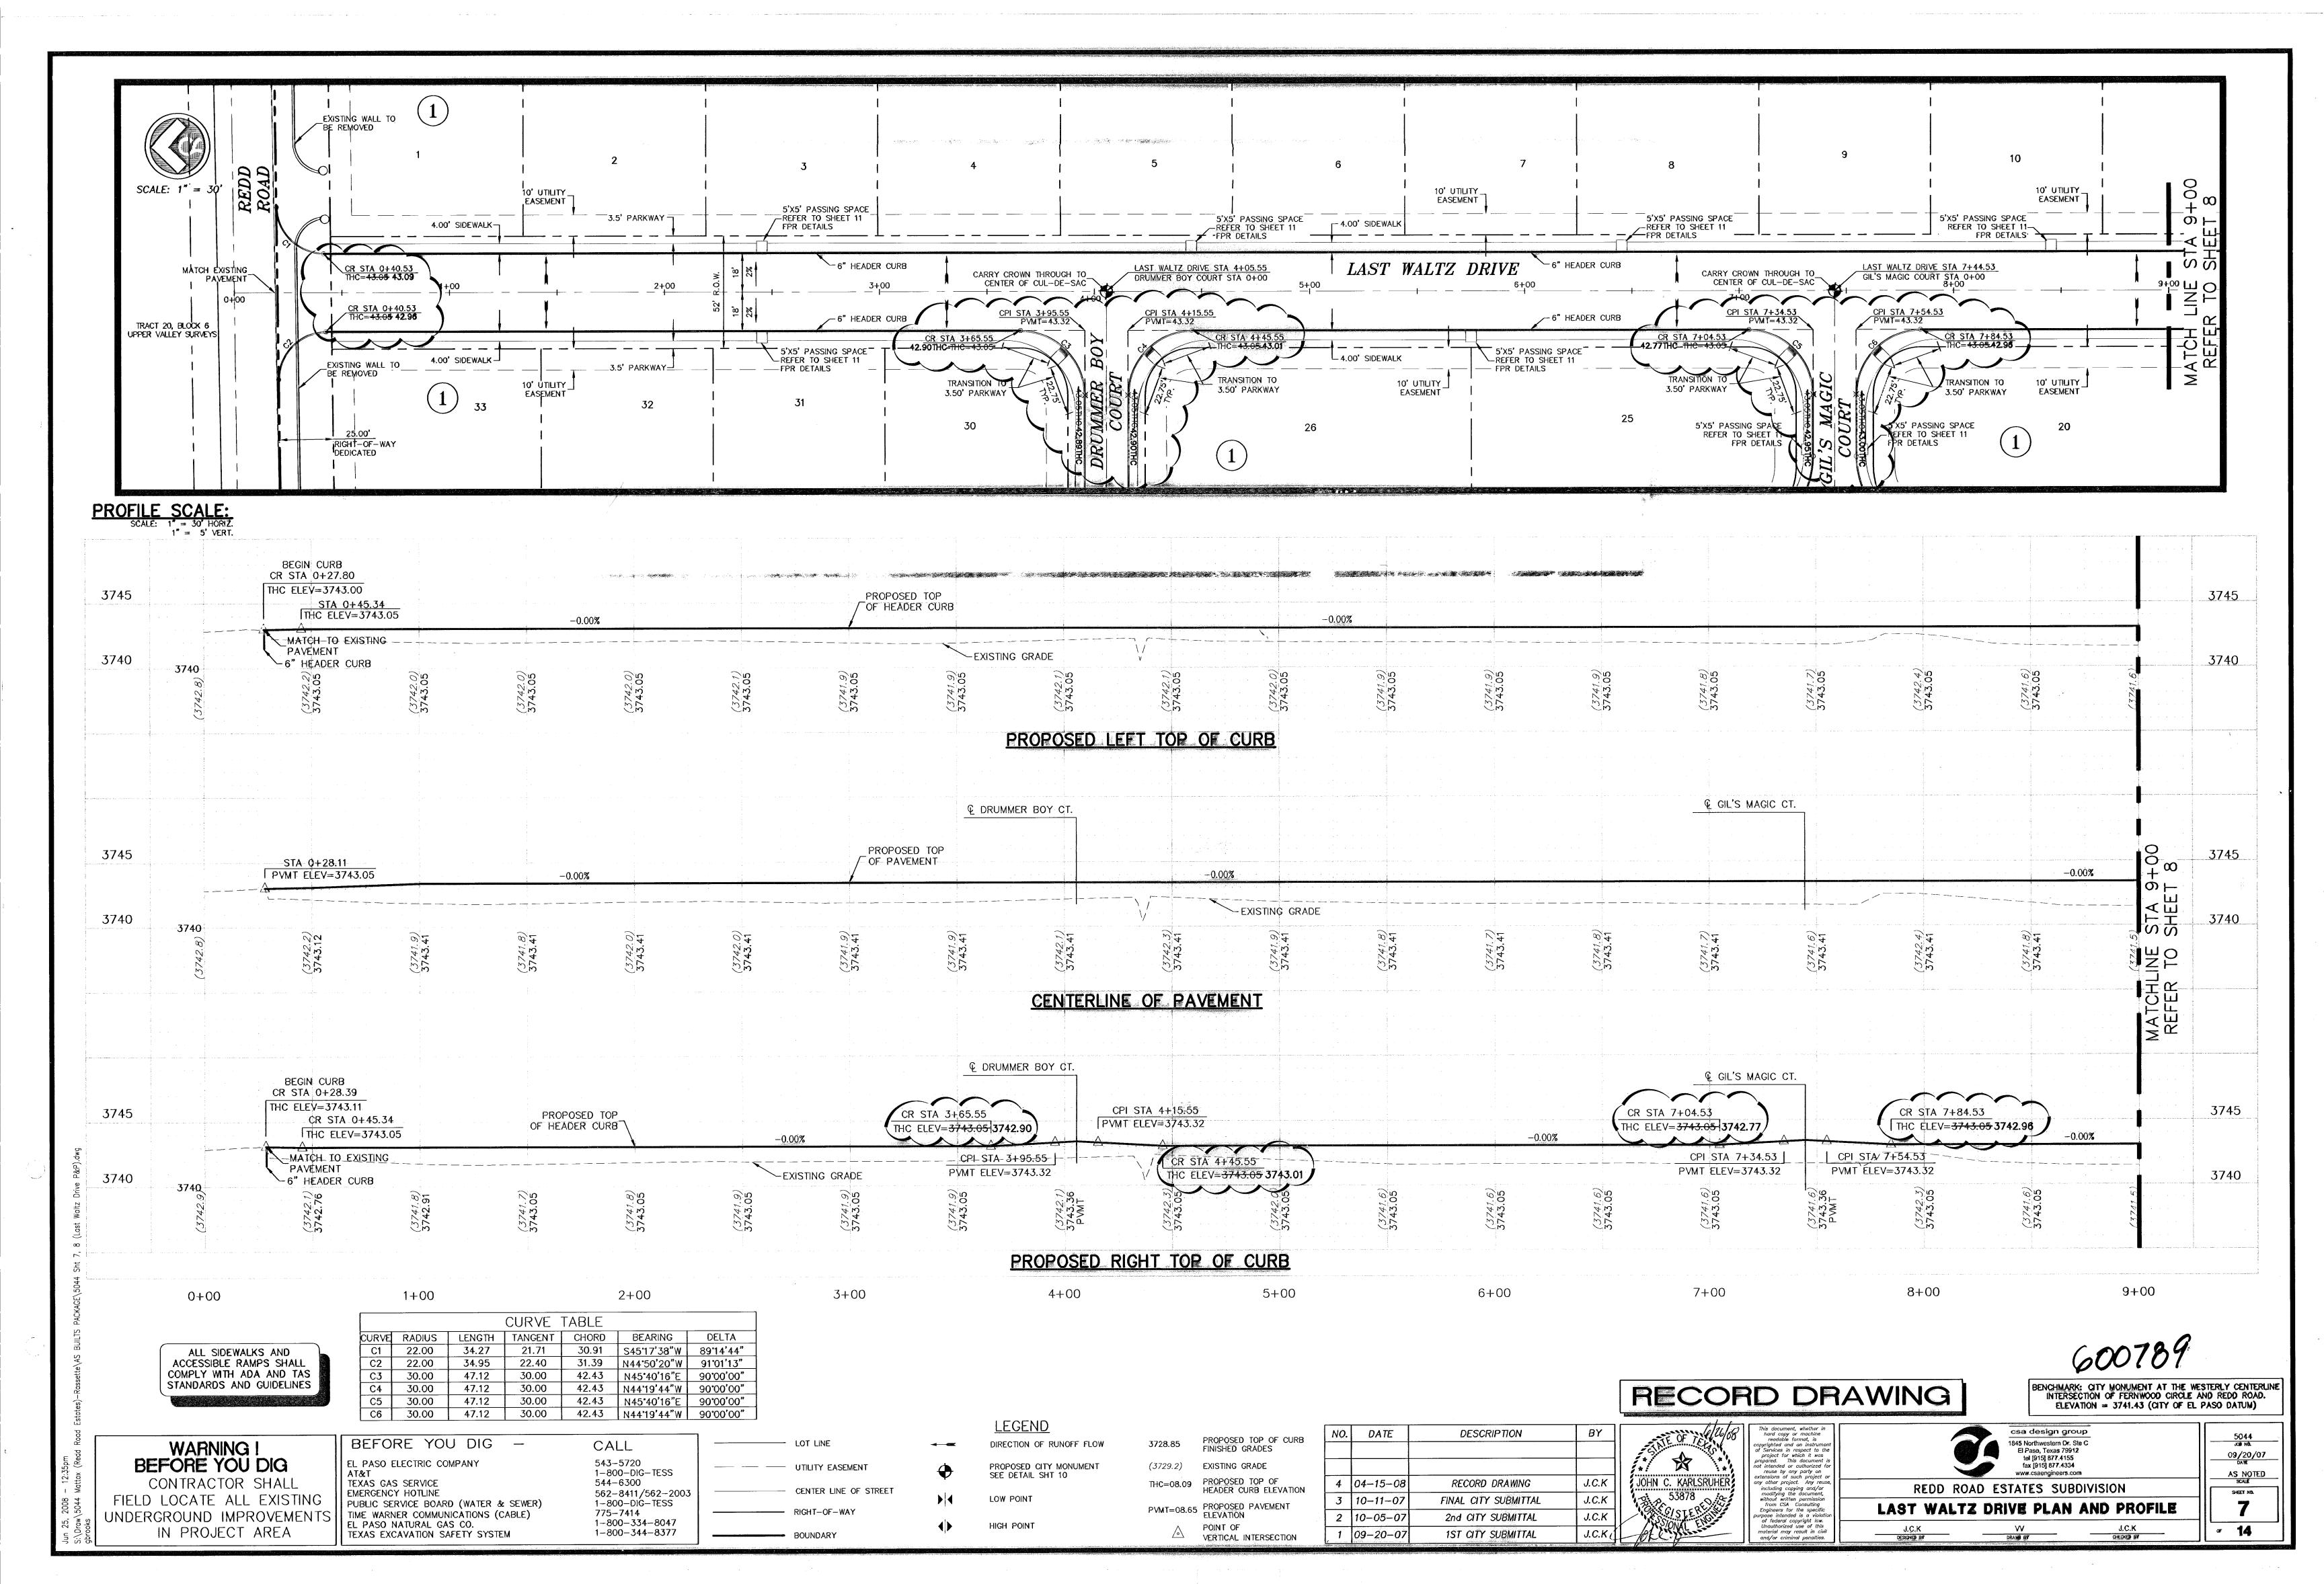

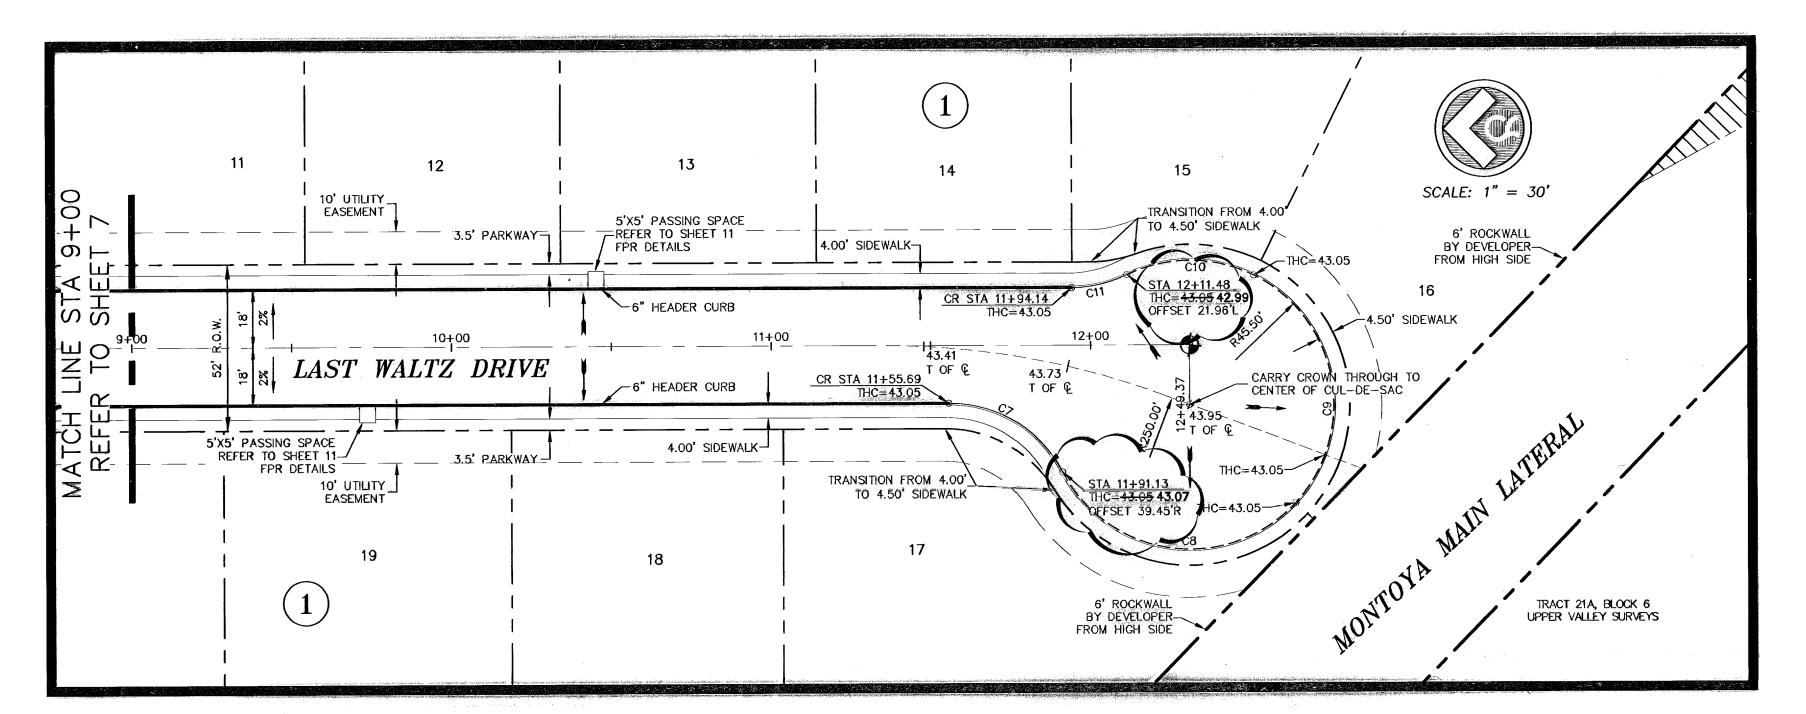

ALL SIDEWALKS AND ACCESSIBLE RAMPS SHALL COMPLY WITH ADA AND TAS STANDARDS AND GUIDELINES

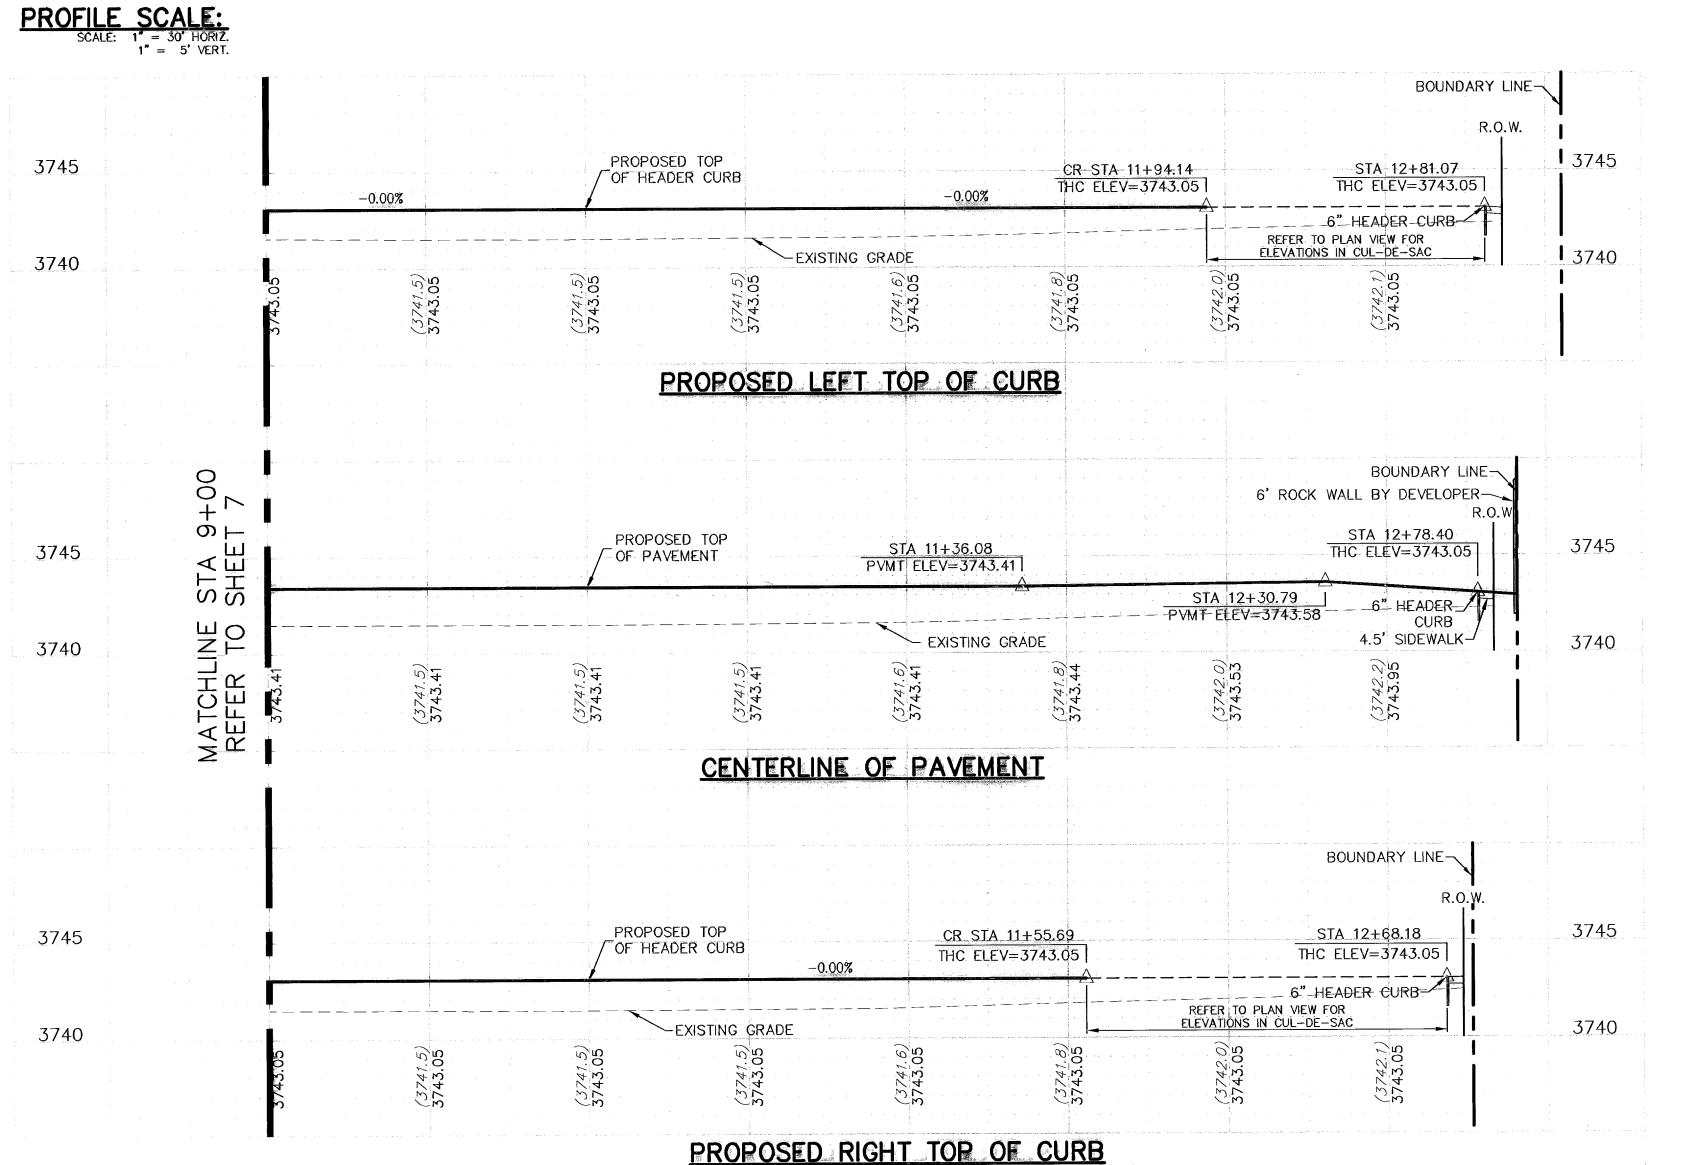

BENCHMARK: CITY MONUMENT AT THE WESTERLY CENTERLINE INTERSECTION OF FERNWOOD CIRCLE AND REDD ROAD. ELEVATION = 3741.43 (CITY OF EL PASO DATUM)

WARNING! BEFORE YOU DIG

CONTRACTOR SHALL FIELD LOCATE ALL EXISTING UNDERGROUND IMPROVEMENT IN PROJECT AREA

BEFORE YOU DIG -CALL 543-5720 EL PASO ELECTRIC COMPANY 1-800-DIG-TESS AT&T 544-6300 TEXAS GAS SERVICE EMERGENCY HOTLINE 562-8411/562-2003 PUBLIC SERVICE BOARD (WATER & SEWER) 1-800-DIG-TESS TIME WARNER COMMUNICATIONS (CABLE) EL PASO NATURAL GAS CO. 775-7414 1-800-334-8047 1-800-344-8377 TEXAS EXCAVATION SAFETY SYSTEM

--- LOT LINE --- UTILITY EASEMENT CENTER LINE OF STREET BOUNDARY

9+00

10+00

LEGEND DIRECTION OF RUNOFF FLOW PROPOSED CITY MONUMENT SEE DETAIL SHT 10 LOW POINT HIGH POINT

PROPOSED TOP OF CURB FINISHED GRADES 3728.85 (3729.2) EXISTING GRADE PROPOSED TOP OF HEADER CURB ELEVATION THC=08.09 PVMT=08.65 PROPOSED PAVEMENT ELEVATION

POINT OF

11 + 00

NO. DATE DESCRIPTION 4 04-15-08 RECORD DRAWING J.C.K FINAL CITY SUBMITTAL 3 10-11-07 J.C.K 2 10-05-07 2nd CITY SUBMITTAL VERTICAL INTERSECTION J.C.K 1 09-20-07 1ST CITY SUBMITTAL

12+00

JOHN C. KARLSRUHER 53878

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RECORD DRAWING


csa design group

1845 Northwestern Dr. Ste C
El Paso, Texas 79912
tel [915] 877.4155
fax [915] 877.4334

REDD ROAD ESTATES SUBDIVISION LAST WALTZ DRIVE PLAN AND PROFILE J.C.K J.C.K DESIGNED BY DRAWN BY

09/20/07 AS NOTED SHEET NO. **4** 14

5044 JOB NO.

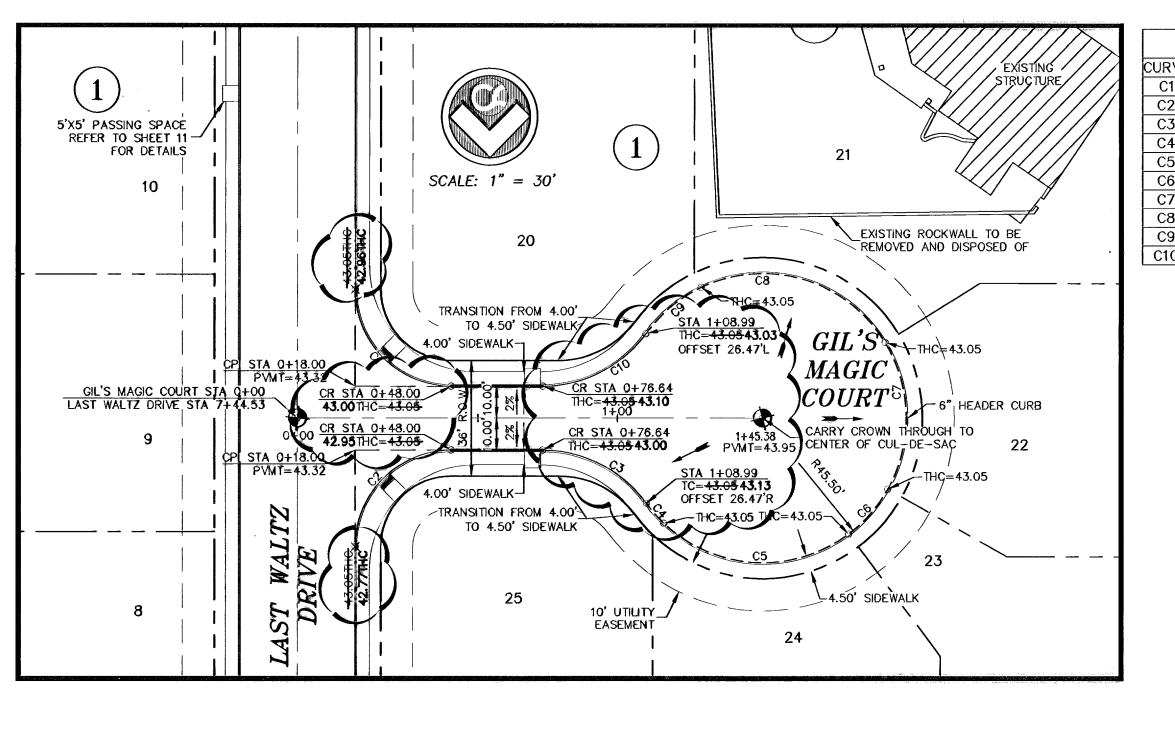

			CURVE	TABLE		
CURVE	RADIUS	LENGTH	TANGENT	CHORD	BEARING	DELTA
C1	30.00	47.12	30.00	42.43	N44°19'44"W	90°00'00"
C2	30.00	47.12	30.00	42.43	N45'40'16"E	90°00′00"
C3	40.00	37.68	20.37	36.30	S62°20'41"E	53*58'05"
C4	45.00	8.27	4.15	8.26	N40°37'26"W	10'31'35"
C5	45.00	63.03	37.93	58.00	N86°00'47"W	80°15′07"
C6	45.00	18.65	9.46	18.52	S41°59'17"W	23'44'45"
C7	45.00	47.94	26.53	45.71	S00°24'25"E	61°02'40"
C8	45.00	65.75	40.32	60.06	S72'47'14"E	83'42'58"
C9	45.00	22.50	11.49	22.27	N51°01'44"E	28*39'06"
C10	40.00	37.68	20.37	36.30	S63'41'14"W	53*58'05"

3745

3740


3745


3740


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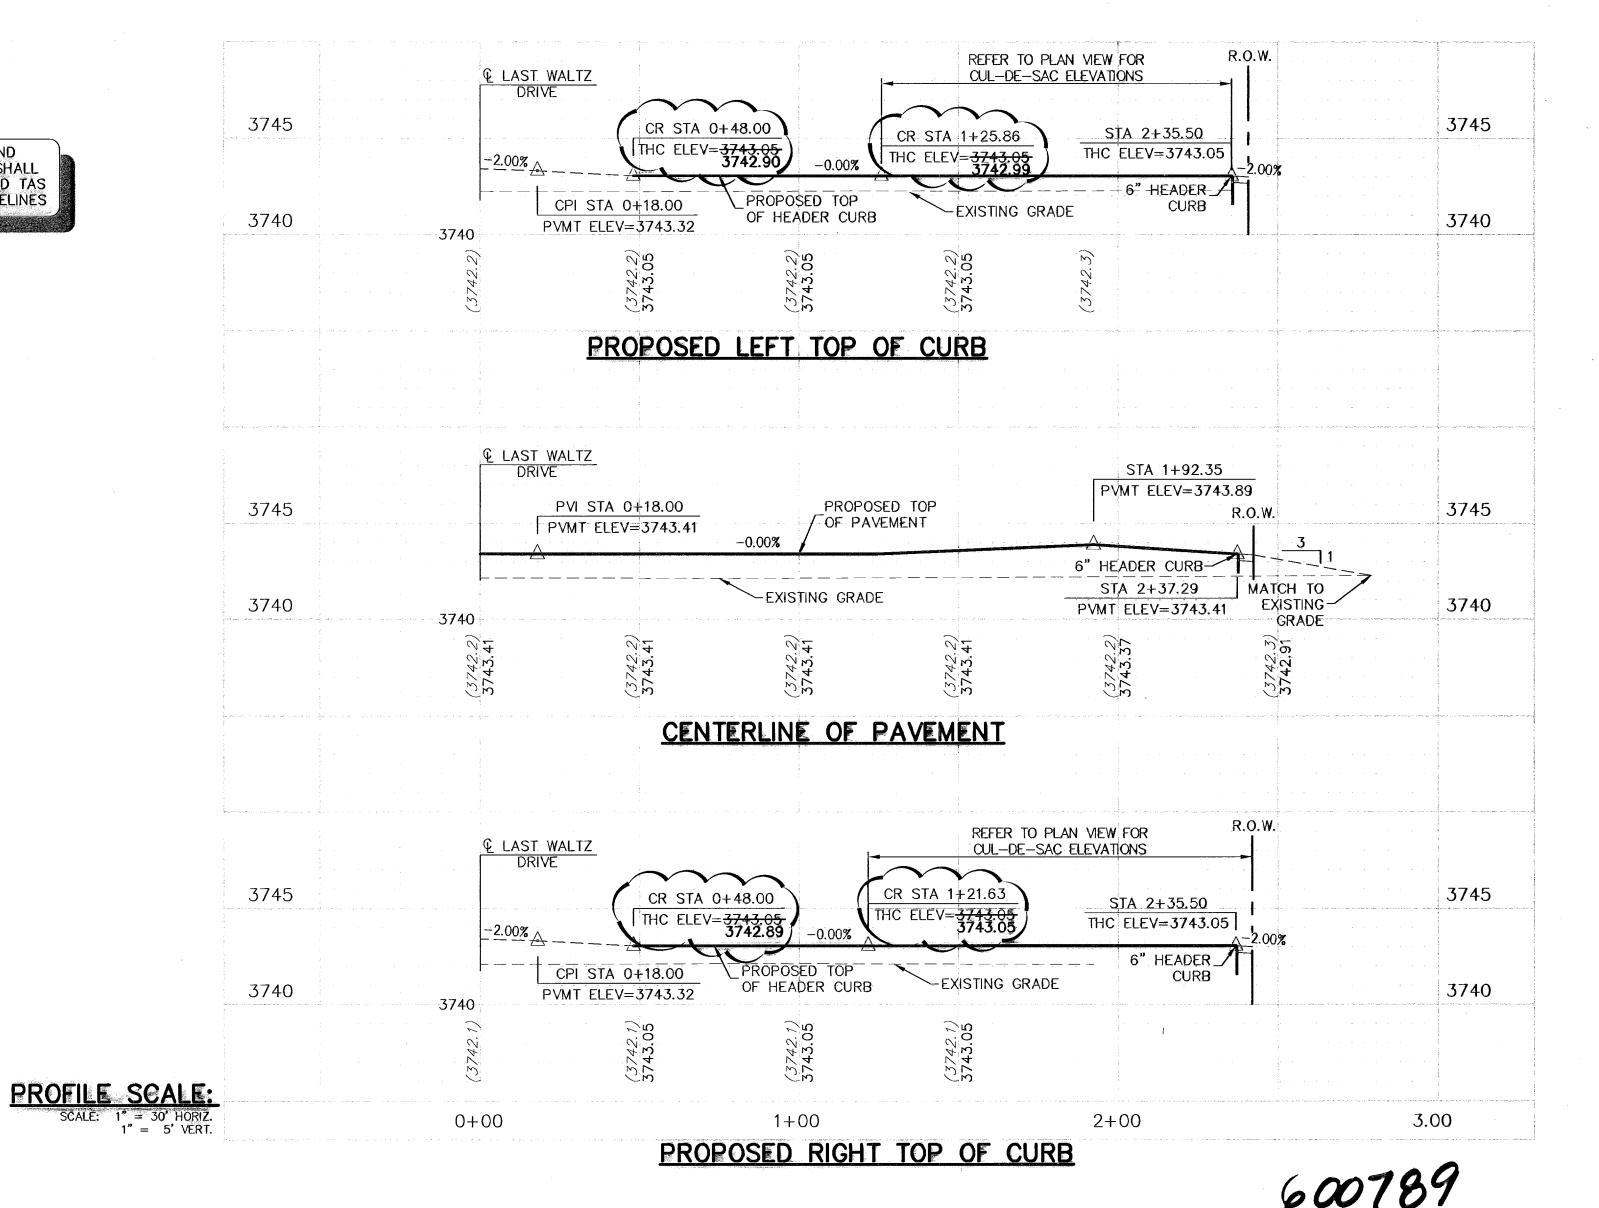
3740

			CURVE	TABLE		
CURVE	RADIUS	LENGTH	TANGENT	CHORD	BEARING	DELTA
C11	30.00	47.12	30.00	42.43	N44°19'44"W	90°00'00"
C12	30.00	47.13	30.00	42.43	N45'40'16"E	90°00'40"
C13	40.00	39.34	21.43	37.78	S61°09'07"E	56°21'12"
C14	45.00	2.48	1.24	2.48	N34'33'17"W	3°09'32"
C15	45.00	110.56	126.28	84.78	S73°28'48"W	140'46'19'
C16	45.00	71.90	46.23	64.49	S42°29'48"E	91*32'26"
C17	45.00	41.29	22.23	39.86	N65°26'53"E	52'34'13"
C18	40.00	35.96	19.30	34.76	S64°55'02"W	51°30′30″



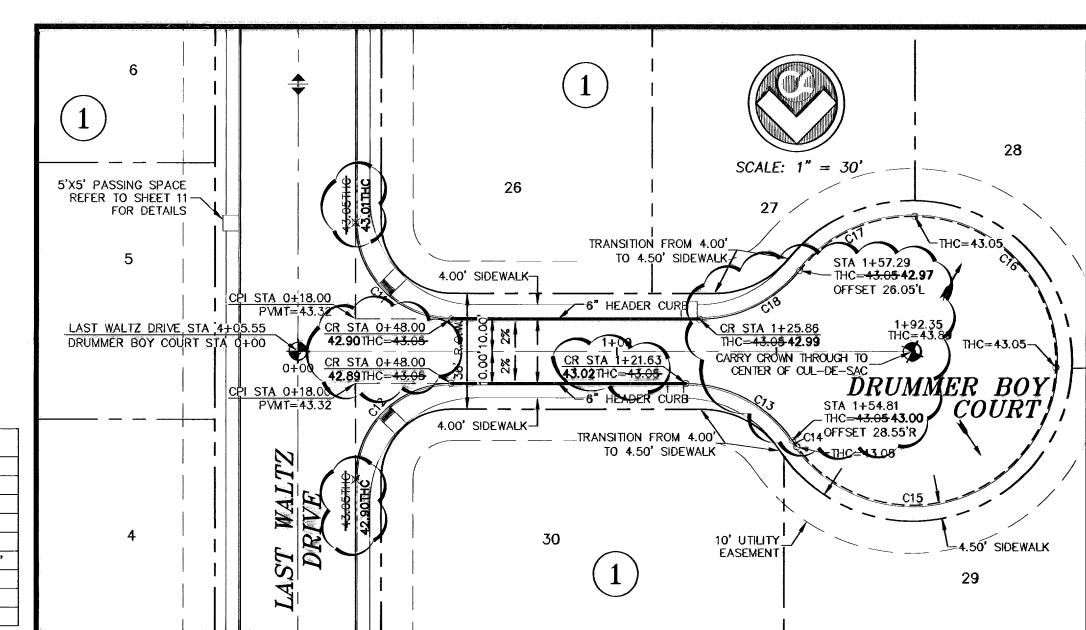

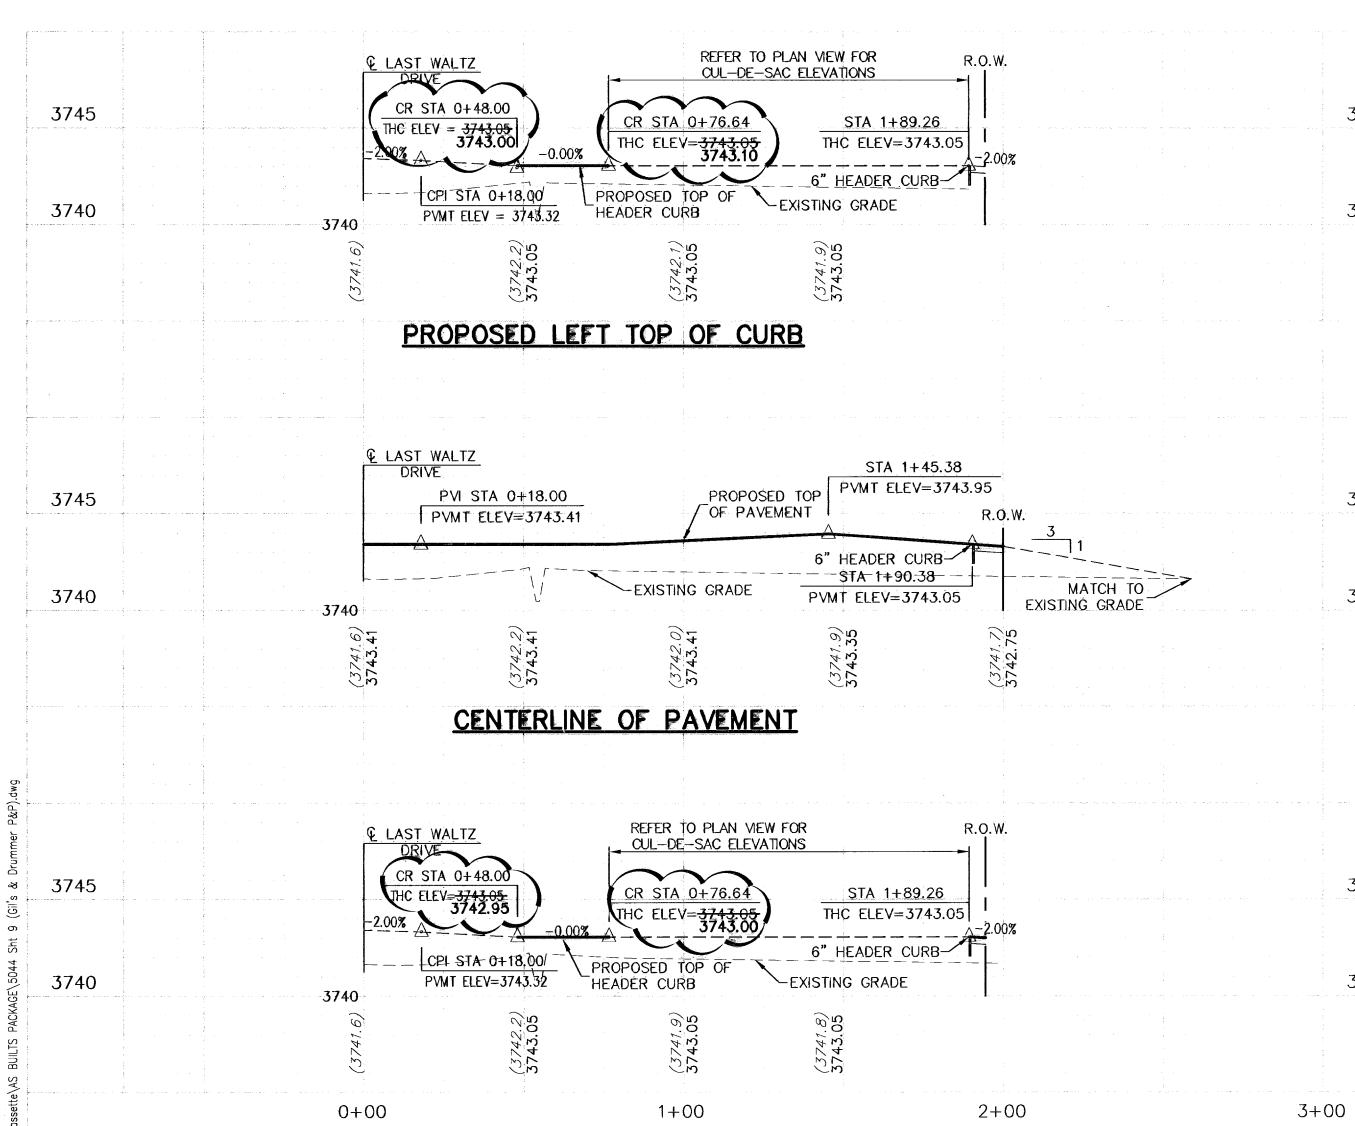

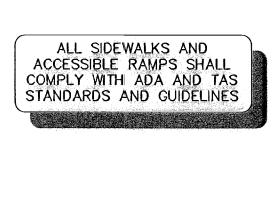

PROPOSED RIGHT TOP OF CURB

WARNING I
BEFORE YOU DIG

CONTRACTOR SHALL
FIELD LOCATE ALL EXISTING

BEFORE YOU DIG —

EL PASO ELECTRIC COMPANY

AT&T

TEXAS GAS SERVICE
EMERGENCY HOTLINE
FUBLIC SERVICE BOARD (WATER & SEWER)

1-

UNDERGROUND IMPROVEMENT

IN PROJECT AREA

LOT LINE

UTILITY EASEMENT

CENTER LINE OF STREET

RIGHT-OF-WAY

BOUNDARY

LEGEND

DIRECTION OF RUNOFF FLOW

PROPOSED CITY MONUMENT
SEE DETAIL SHT 10

LOW POINT

HIGH POINT

3728.85 PROPOSED TOP OF CURB FINISHED GRADES

(3729.2) EXISTING GRADE

THC=08.09 PROPOSED TOP OF HEADER CURB ELEVATION

PVMT=08.65 PROPOSED PAVEMENT ELEVATION

POINT OF

VERTICAL INTERSECTION

 NO.
 DATE
 DESCRIPTION
 BY

 4
 04-15-08
 RECORD DRAWING
 J.C.K

 3
 10-11-07
 FINAL CITY SUBMITTAL
 J.C.K

 2
 10-05-07
 2nd CITY SUBMITTAL
 J.C.K

 1
 09-20-07
 1ST CITY SUBMITTAL
 J.C.K

JOHN C. KARLSRUHER

JOHN C. KARLSRUHER

53878

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BENCHMARK: CITY MONUMENT AT THE WESTERLY CENTERLINE
INTERSECTION OF FERNWOOD CIRCLE AND REDD ROAD.
ELEVATION = 3741.43 (CITY OF EL PASO DATUM)

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Op/20/07




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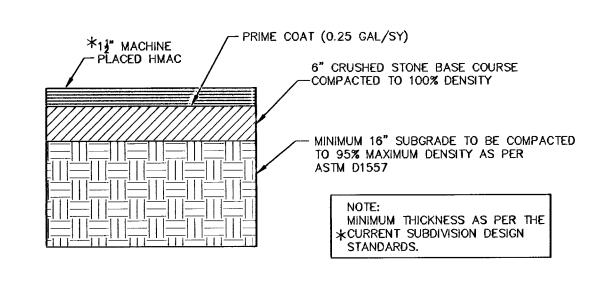
J.C.K

CHECKED BY




- 1. PROVIDE TRANSVERSE CONTRACTION JOINTS AT INTERVALS NOT EXCEEDING 5'-0" O.C. 2. PROVIDE EXPANSION JOINTS AT INTERVALS NOT EXCEEDING 20'-0" O.C. AND ALONG FEATURES THAT PROJECT THROUGH OR ADJACENT TO SIDEWALK 3. CONCRETE SHALL HAVE A MINIMUM COMPRESSIVE STRENGTH OF 3000 PSI AT 28 DAYS
- 4. EXPANSION JOINT FILLER SHALL BE 1/2" BITUMINOUS TYPE PREFORMED JOINT FILLER, 5. WHEREVER SIDEWALK ABUTS ROCK OR MASONRY STRUCTURES SUCH AS CURBS OR BUILDINGS, EXPANSION JOINT FILLER SHALL BE PLACED IN ACCORDANCE WITH STANDARD

TYPICAL SIDEWALK DETAILS

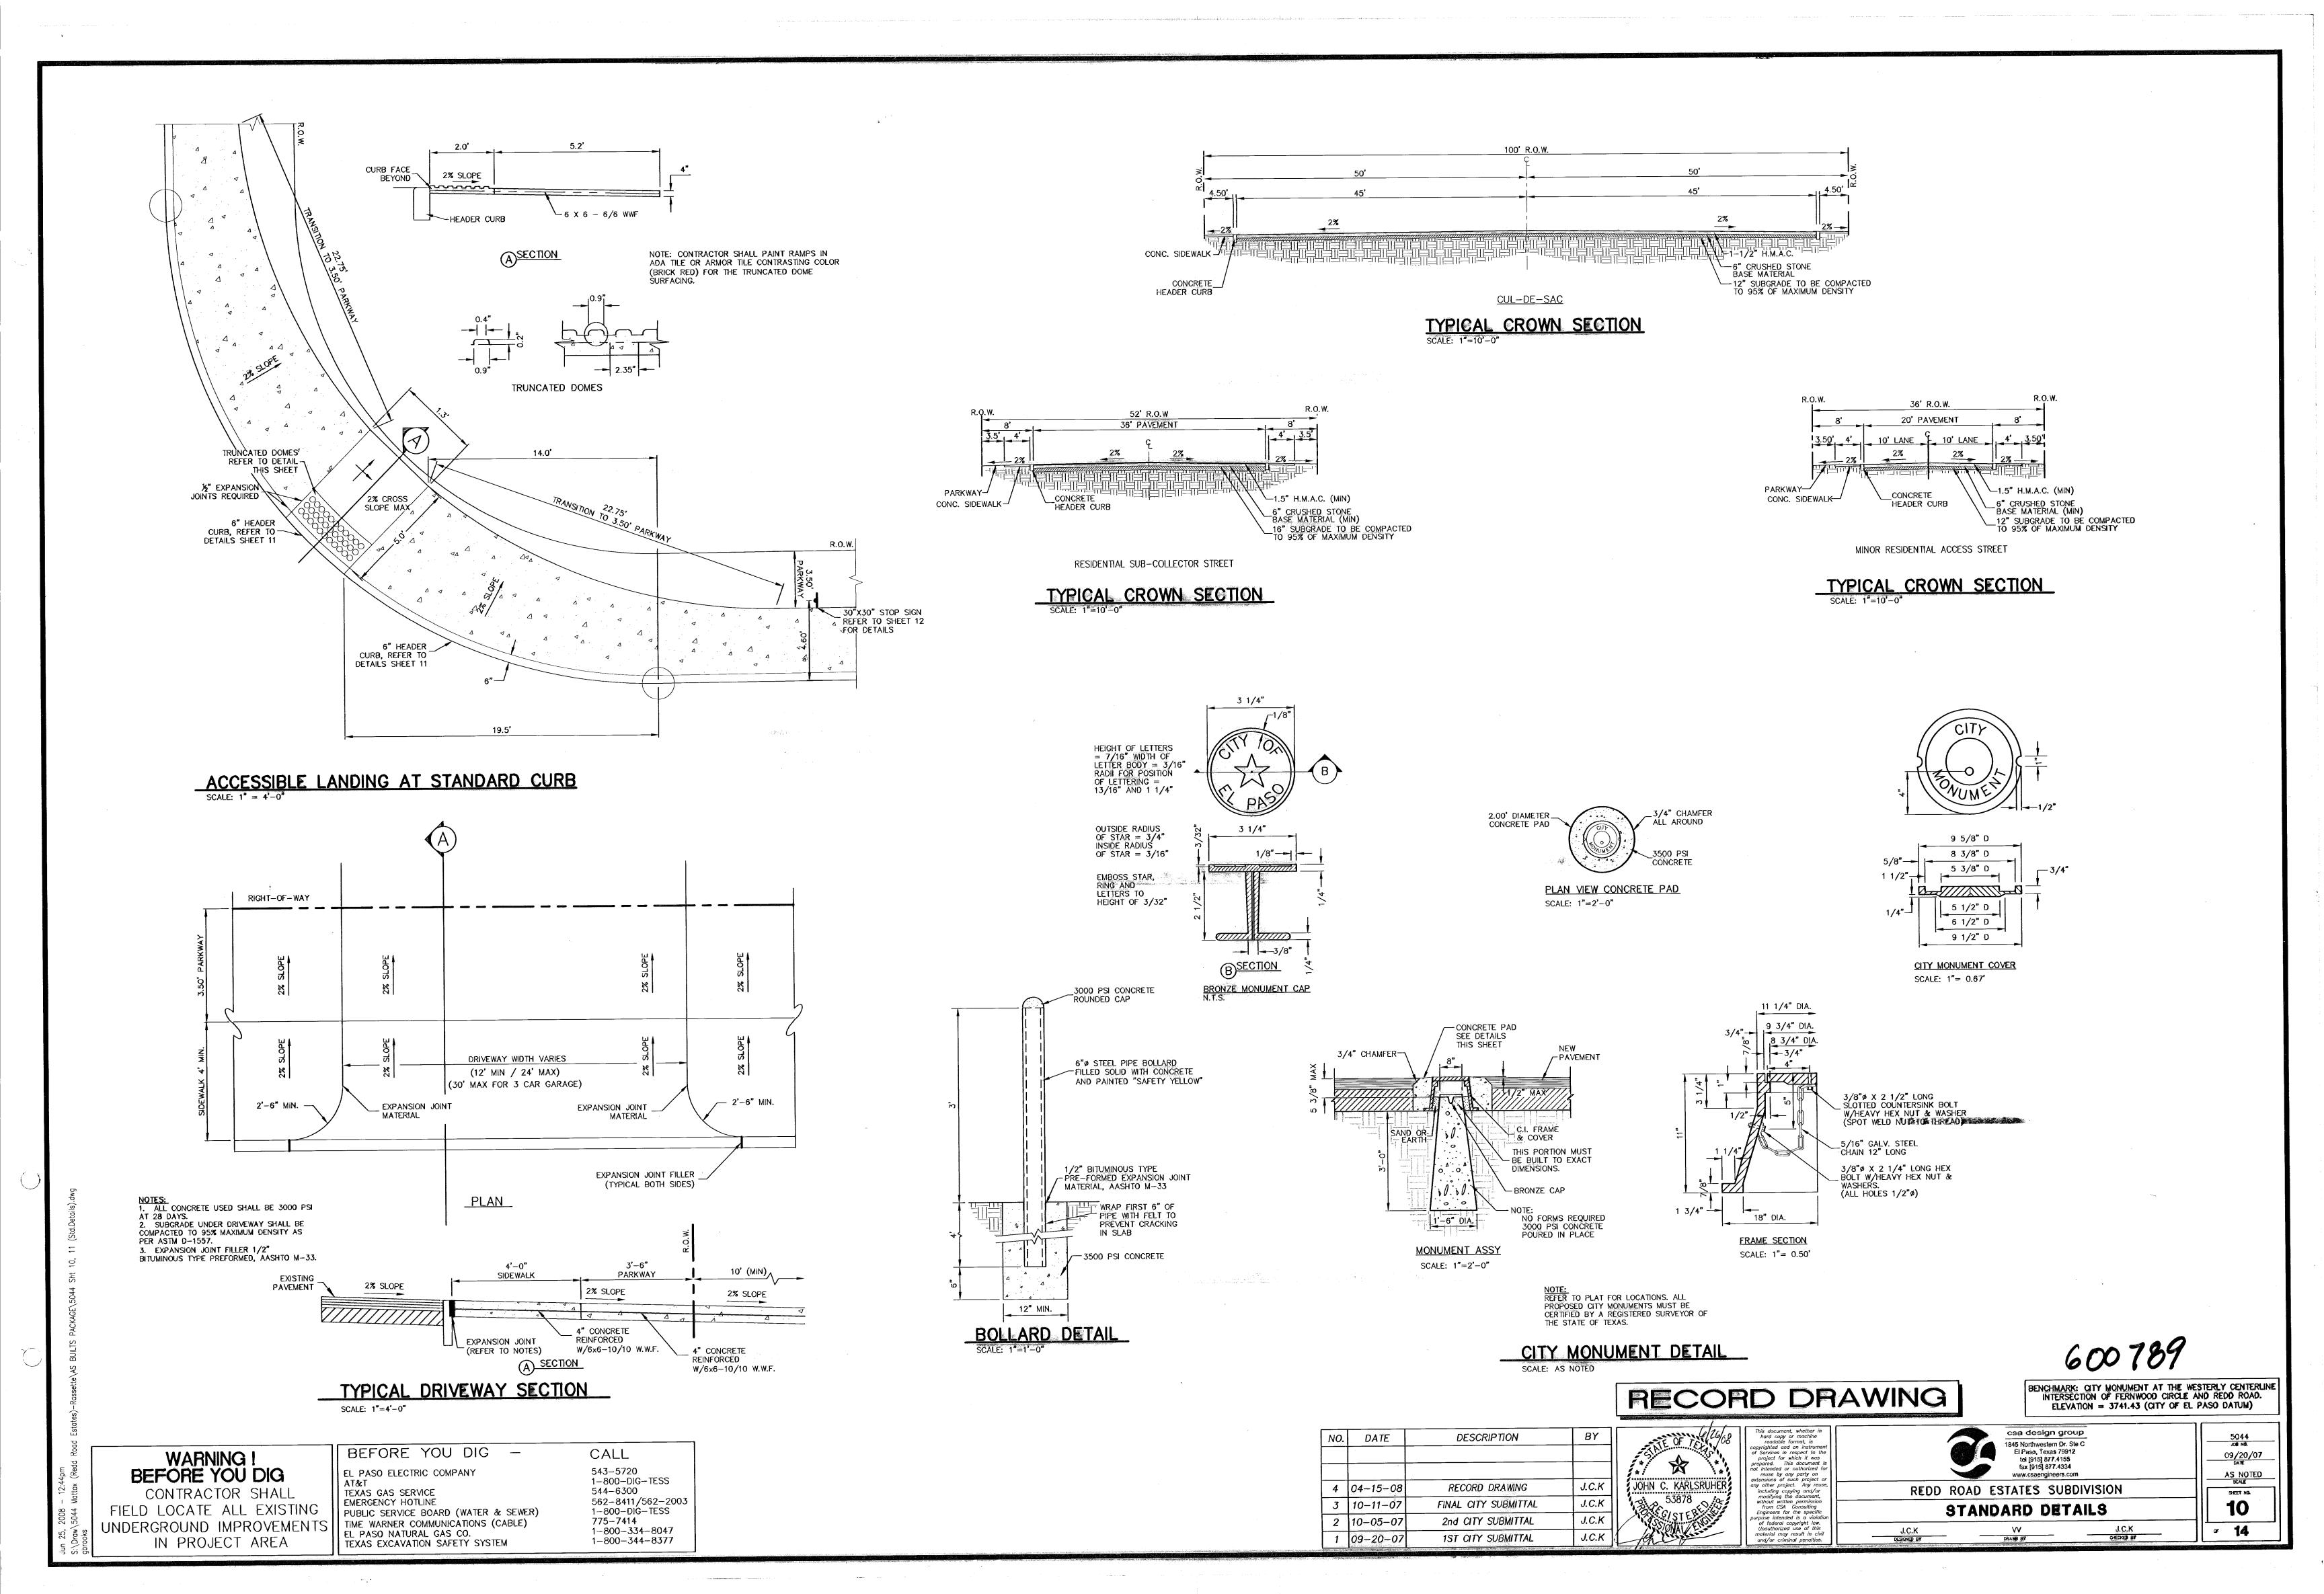


TYPICAL HMAC PAVEMENT SECTION FOR LAST WALTZ DRIVE

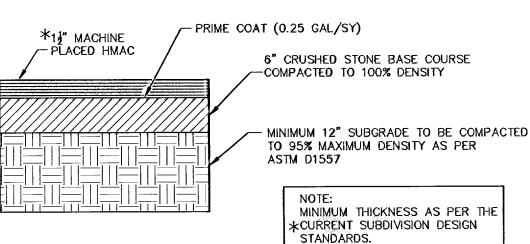

TYPICAL HMAC PAVEMENT SECTION FOR DRUMMER BOY COURT & GIL'S MAGIC COURT

GENERAL H.M.A.C. PAVING NOTES:

- 1. PAVEMENT DESIGN PER GEOTECHNICAL INVESTIGATION REPORT BY SOIL MECHANICS INTERNATIONAL PROJECT NO. SMF06166 DATED AUGUST 6, 2006.
- 2. BASE COURSE SHALL MEET THE REQUIREMENTS FOR TYPE "A", GRADE 1 OR 2 MATERIAL ACCORDING TO ITEM 247, FLEXIBLE BASE, AS DESCRIBED IN THE TEXAS DEPARTMENT OF TRANSPORTATION STANDARD SPECIFICATIONS FOR CONSTRUCTION OF HIGHWAYS, STREETS, AND BRIDGES. ALL THE REQUIREMENTS OF THIS DOCUMENT SHALL BE MET, EXCEPT WHERE DENSITY IS SPECIFIED. THE DENSITY SHALL BE NOT LESS THAN 100% OF ASTM D1557.
- 3. THE SURFACE COARSE SHALL MEET THE REQUIREMENTS FOR (HMAC), TXDOT TYPE "C" AS SPECIFIED IN ITEM 340 HMAC (HOT MIX ASPHALTIC CONCRETE PAVEMENT), AS DESBRIBED IN THE TEXAS DEPARTMENT OF TRANSPORTATION STANDARD SPECIFICATIONS FOR CONSTRUCTION OF HIGHWAYS, STREETS, AND BRIDGES. STABILITY SHALL BE NOT LESS THAN 1500 POUNDS. WHEN COMPACTED AT 75 BLOWS. FURTHERMORE, THE MIX SHALL HAVE A FLOW BETWEEN 0.08" AND 0.16", ACCORDING TO THE MARSHALL STABILITY
- 4. SUBGRADE TO BE COMPACTED IN 4" LIFTS TO 95% MAXIMUM DENSITY AS PER
- ASTM D1557. 5. FINAL PAVEMENT DESIGN TO BE DETERMINED BASED UPON FINAL CBR TEST RESULTS.

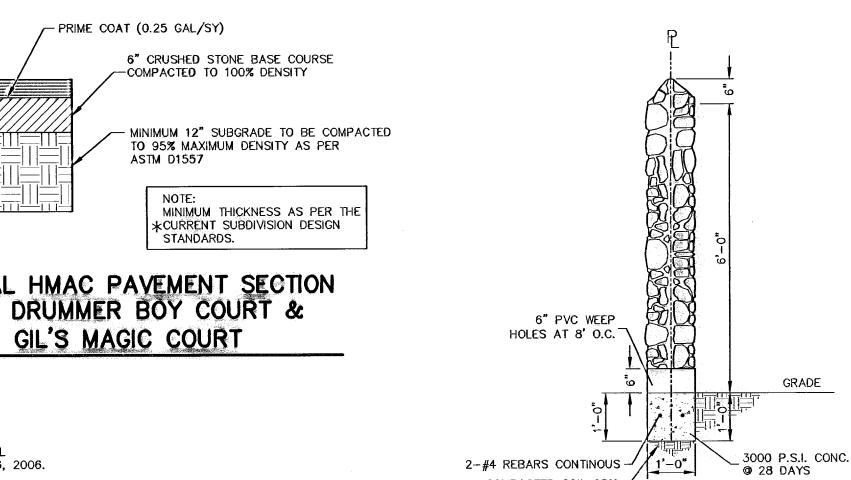


AS PER ASTM D-1557 ROCKWALL DETAIL

COMPACTED SOIL 95% /

GRADE

95% COMPACTION PER ASTM D-1557

2' EARTHEN BERM

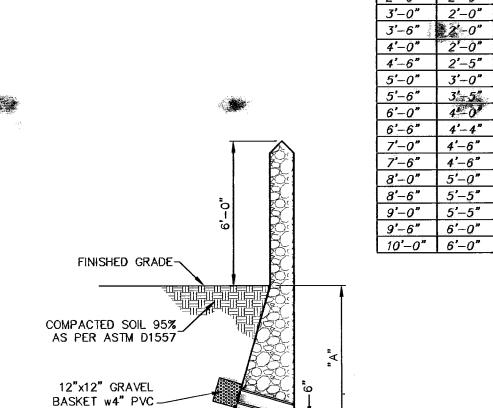

PIPE AT 10' O.C.

COMPACTED SOIL 95%

AS PER ASTM D-1557

1. Footing shall be placed on subgrade compacted to a minimum of 95% of its maximum dry density in accordance with ASTM D 1557. Backfill shall be placed in 6" loose lifts and

ROCK RETAINING WALL BY DEVELOPER

compacted to 95% in accordance with ASTM D 1557.

#4 BARS AT 12" O.C.

~#4 BARS AT 18" O.C.

ROCKWALLS

MATERIALS: Stone for rockwalls shall consist of quarried limestone as nearly uniform in section as is practicable. Field stone or salvaged stone from rockwalls shall be used only where directed by the Engineer. The stone shall be dense, resistant to the action of air and water, clean of old mortar and suitable in all respects for the purpose intended.


Mortar for the rockwalls shall consist by volumes of one (1) part portland cement, one—quarter to one—half (1/4 TO 1/2) part hydrated lime, and three (3) parts clean, hard, durable sand (2 1/4 to 3 times the sum of the volumes of cement and lime combined. See city building code PP. 14-3 and 14-4). Mortar shall be Type S, ASTM Specification C270-73. Compressive strength = 1800 p.s.i. (28 days).
Concrete for the foundation shall be Class "A" (3000 p.s.i.).
Reinforcing steel shall conform to ASTM A 615, Grade 60. If rockwall is frequently exposed to water, lime shall not be used and the portions shall be one part portland cement and three parts sand.

CONSTRUCTION METHODS: Prior to placing the concrete foundation, the excavation for the rockwalls shall be made to the proper section, and, if considered necessary by the Engineer, the bottom of excavation shall be hand-tamped and sprinkled. The excavated area for rockwalls shall be moist when the concrete is placed. Reinforcing steel shall be placed continuously as shown on the plans and properly supported throughout the placement of concrete. The surface of the concrete shall not be troweled. The concrete shall be cured a minimum of 24 hours before any stone or mortar is placed on the foundation. The concrete shall be cured a minimum of 48 hours before more than 300 pounds per square foot of stone and mortar is placed on the foundation. Contractor shall embed the first four inches of the first layer into the fresh concrete of the


Stone shall be selected as to size and shape in order to secure fairly large, flat-surfaced stone which may be erected with true and even surface faces and a minimum of exposed mortar. All stones shall be thoroughly cleaned, wetted, hand-placed and embedded in mortar so that no stones shall touch each other or the concrete foundation but shall be firmly bound together with mortar. The finished surface shall present a neat, clean, workmanlike and true-to-line appearance. The interior of the rockwall shall be completely filled with spalls and pieces of the specified stone, completely embedded and surrounded by mortar with

The erection of the rockwall shall not be more than three feet in height for every 24-hour period to allow for the lower portions to become sufficiently set. All stones shall be thoroughly wet before being placed in fresh mortar. The last layer of rock prior to break of construction phase shall not have any mortar on top. Fresh mortar must be used for continuation of work following erection


Weep holes shall be placed on the rockwall as shown on the plans. The weep holes shall be not more than ten feet apart on-center. The weep holes shall consist of four-inch vitrified clay pipe, or other pipe as approved by the Engineer, neatly cut to the exposed surface of the rockwall. No less than one cubic foot of one-inch to 3/4inch of graded gravel shall be placed at the inlet of each weep hole as shown on the plans.

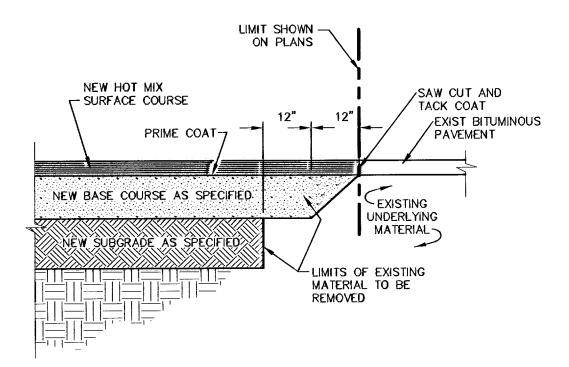


JUNCTURE OF NEW FLEXIBLE AND EXISTING FLEXIBLE PAVEMENT SCALE: 1"=2'-0"

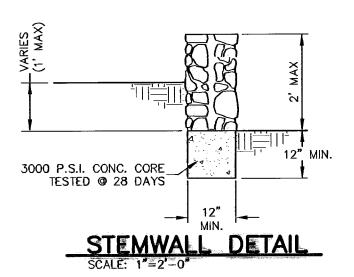

STEMWALLS INSTALLED BETWEEN LOTS SUBJECT TO ON-SITE PONDING MUST INCLUDE 6" PVC WEEP HOLES @10' O.C. WITH INVERT OF PIPE AT GROUND LEVEL.

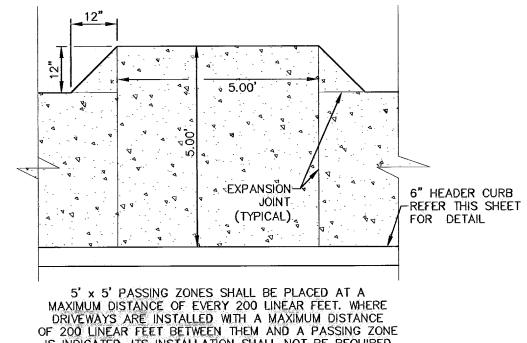

ACCESSIBLE PASSING SPACE (5'X5')

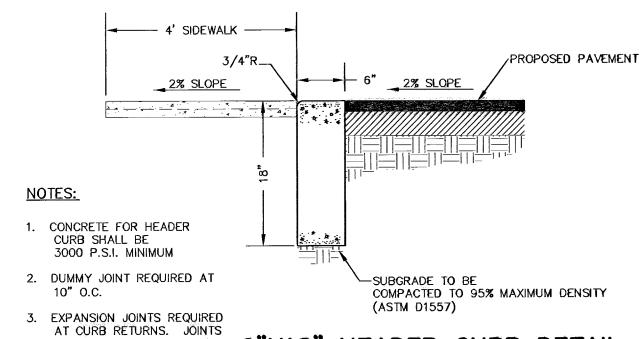

6"X18" HEADER CURB DETAIL TO BE PACKED WITH 1/2" PREMOLDED ASPHALT IMPREGNATED EXPANSION MATERIAL OR EQUAL.

BENCHMARK: CITY MONUMENT AT THE WESTERLY CENTERLINE INTERSECTION OF FERNWOOD CIRCLE AND REDD ROAD. ELEVATION = 3741.43 (CITY OF EL PASO DATUM)

600789

WARNING! BEFORE YOU DIG

CONTRACTOR SHALL FIELD LOCATE ALL EXISTING UNDERGROUND IMPROVEMENT IN PROJECT AREA

BEFORE YOU DIG -EL PASO ELECTRIC COMPANY TEXAS GAS SERVICE


EMERGENCY HOTLINE PUBLIC SERVICE BOARD (WATER & SEWER) TIME WARNER COMMUNICATIONS (CABLE) EL PASO NATURAL GAS CO. TEXAS EXCAVATION SAFETY SYSTEM


CALL 543-5720 1-800-DIG-TESS 544-6300 562-8411/562-2003 1-800-DIG-TESS 775-7414 1-800-334-8047 1-800-344-8377


RECORD DRAWING


csa design group 1845 Northwestern Dr. Ste C El Paso, Texas 79912 tel [915] 877.4155 fax [915] 877.4334

DATE DESCRIPTION 5044 JOB NO. opyrighted and an instrument of Services in respect to the project for which it was prepared. This document is 09/20/07 AS NOTED JOHN C. KARLSRUHER RECORD DRAWING 4 | 04-15-08 | ny other project. Any reu ny other project. Any reison including copying and/or modifying the document, without written permission from CSA Consulting Engineers for the specific unpose intended is a violation of federal copyright law. Unauthorized use of this material may result in civil and/or criminal penalties. REDD ROAD ESTATES SUBDIVISION SHEET NO. 53878 FINAL CITY SUBMITTAL J.C.K 3 10-11-07 11 STANDARD DETAILS J.C.K 2 10-05-07 2nd CITY SUBMITTAL · 14 09-20-07 1ST CITY SUBMITTAL J.C.K CHECKED BY DESIGNED BY

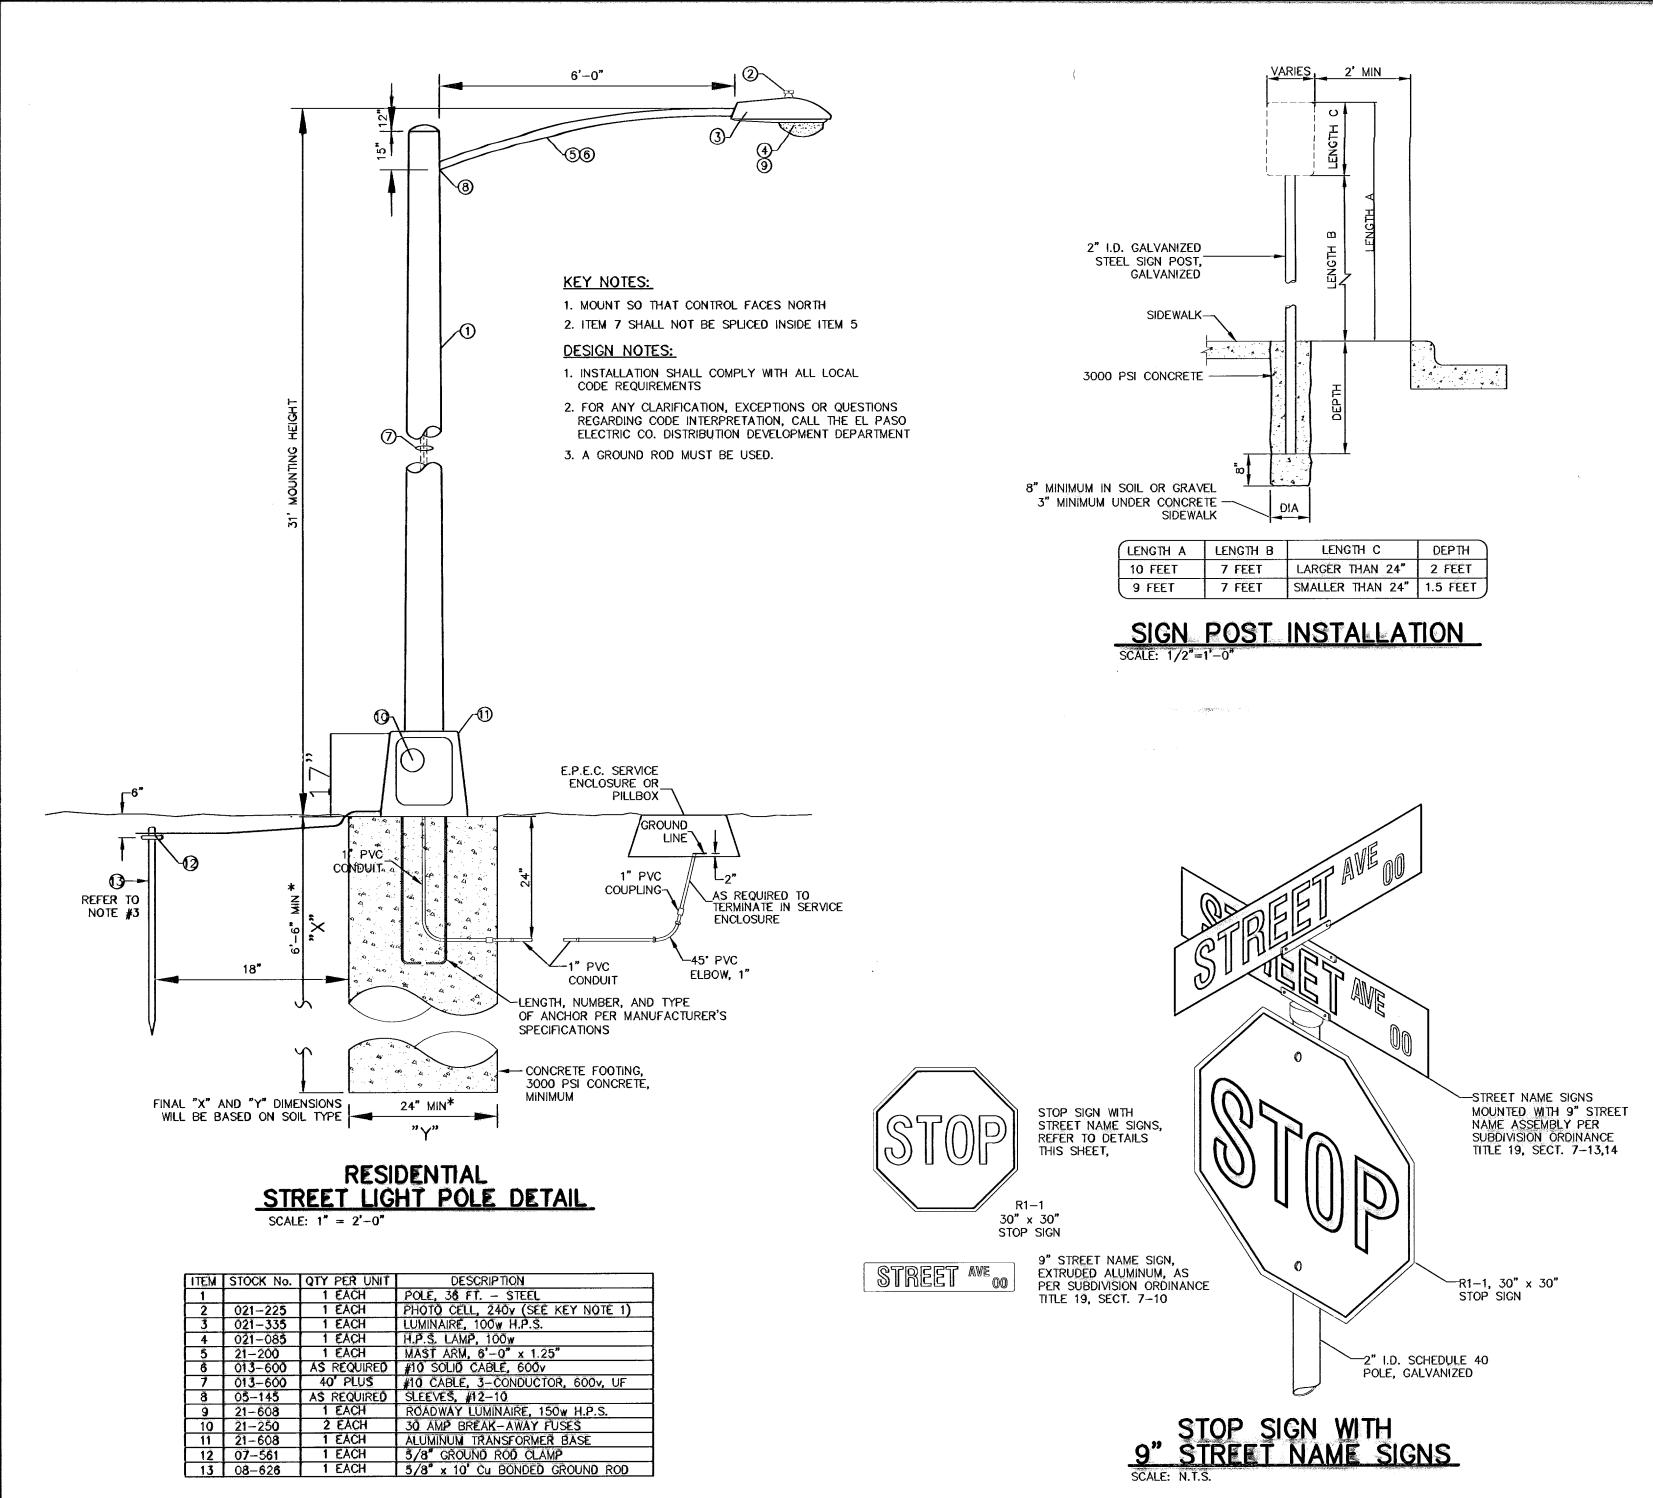

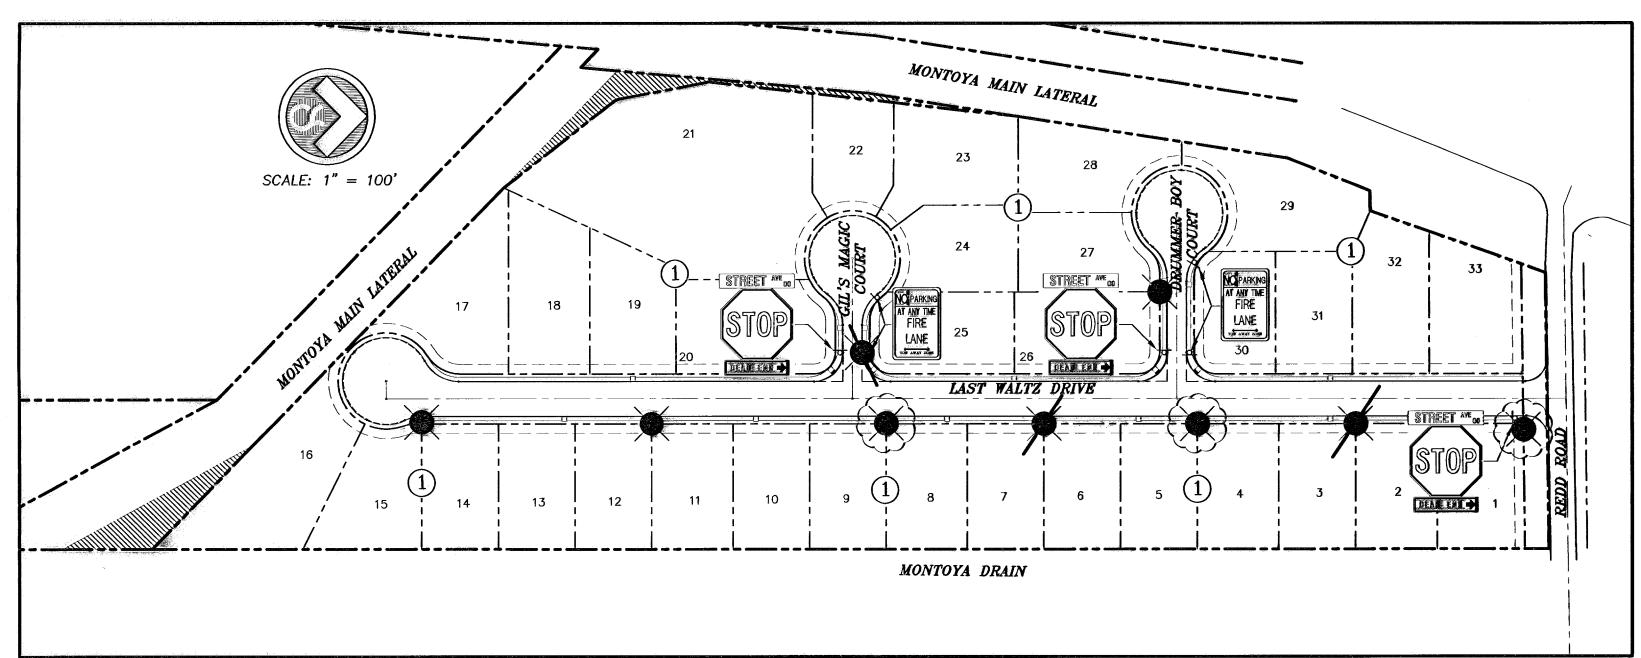

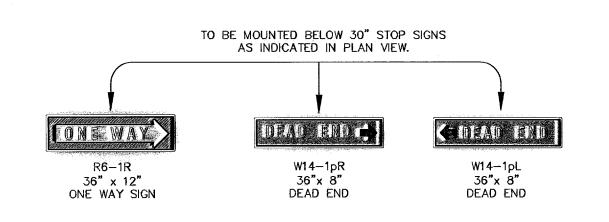

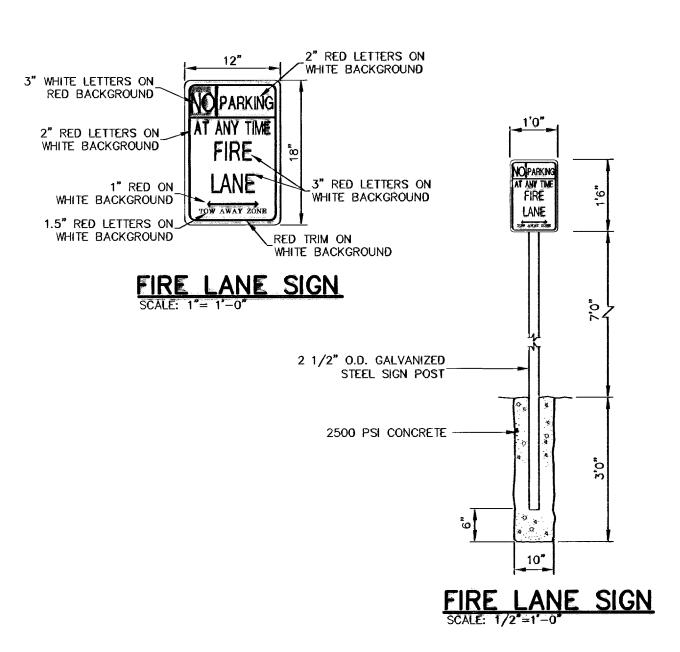

DEPARTMENT OF TRAFFIC AND TRANSPORTAITON

ILLUMINATION PLAN APPROVED 09/22/07

600789

ALL ROADWAYS INTERSECTING EXISTING PUBLIC ROADWAYS SHALL REMAIN COMPLETELY CLOSED FOR PUBLIC USE UNTIL ACCEPTED FOR MAINTENANCE BY THE CITY.

RECORD DRAWING

BENCHMARK: CITY MONUMENT AT THE WESTERLY CENTERLINE INTERSECTION OF FERNWOOD CIRCLE AND REDD ROAD.

ELEVATION = 3741.43 (CITY OF EL PASO DATUM)

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4	04-15-08	RECORD DRAWING	J.C.K	JOHN C. KARLSRUHER	extensions of such project or any other project. Any reuse, including copying and/or	REDD ROAD ESTAT	ES SUBDIVISION	SCALE SHEET NO.
3	10-11-07	FINAL CITY SUBMITTAL	J.C.K	53878	modifying the document, without written permission from CSA Consulting			12
2	10-05-07	2nd CITY SUBMITTAL	J.C.K	SSIE	Engineers for the specific purpose intended is a violation of federal copyright law.	ILLUMINATI	ION PLAN	
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WARNING ! BEFORE YOU DIG

CONTRACTOR SHALL FIELD LOCATE ALL EXISTING UNDERGROUND IMPROVEMENT IN PROJECT AREA

BEFORE YOU DIG -EL PASO ELECTRIC COMPANY

TEXAS GAS SERVICE EMERGENCY HOTLINE PUBLIC SERVICE BOARD (WATER & SEWER) TIME WARNER COMMUNICATIONS (CABLE) EL PASO NATURAL GAS CO.
TEXAS EXCAVATION SAFETY SYSTEM

CALL 543-5720 1-800-DIG-TESS 544-6300 562-8411/562-2003 1-800-DIG-TESS

775-7414


1-800-334-8047


1-800-344-8377

PROPOSED STREET LIGHTS REQUIRED AS PER CITY ORDINANCE 13


<u>LEGEND</u>


STOP SIGN AND/OR STREET NAME

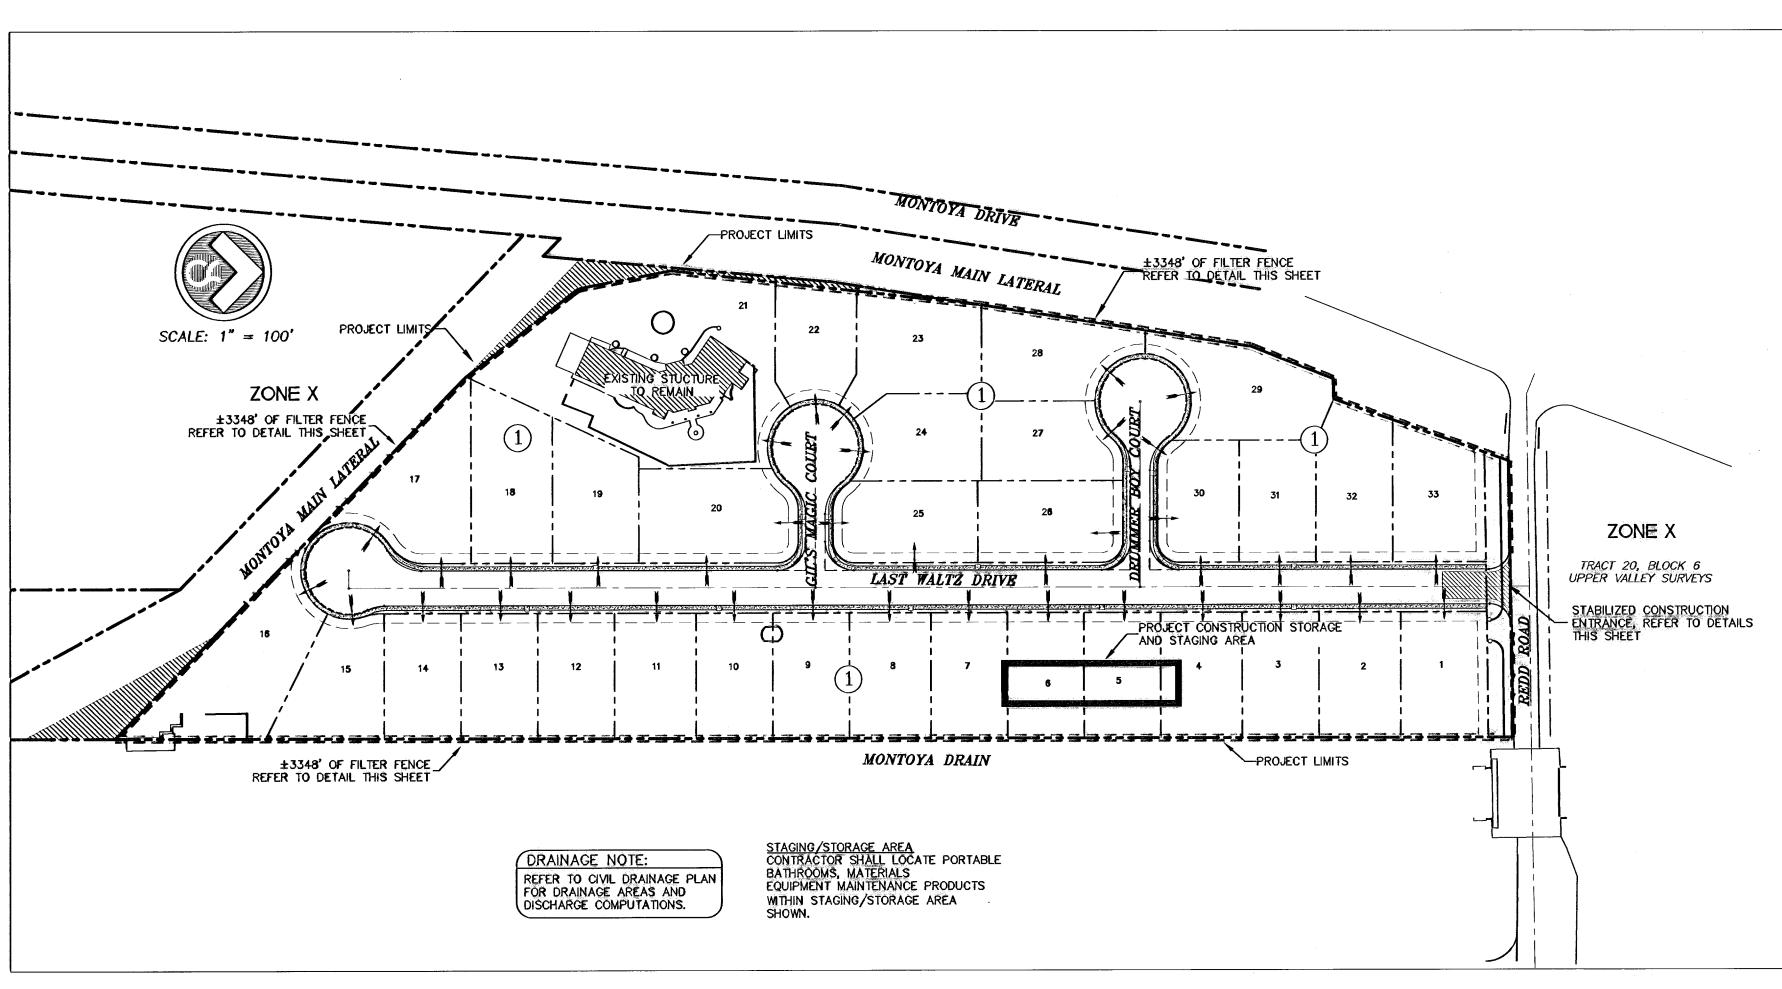

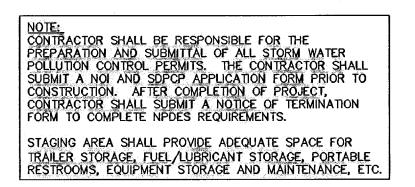


DUST AND EROSION CONTROL NOTE: DUST AND EROSION CONTROL WHERE EXTENSIVE DIRT OR DUST OPERATIONS ARE PERFORMED. USE WATER SPRINKLING AND OTHER METHODS TO LIMIT DUST AND DIRT MIGRATION. COMPLY WITH GOVERNING REGULATIONS

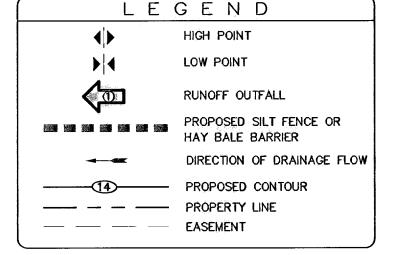

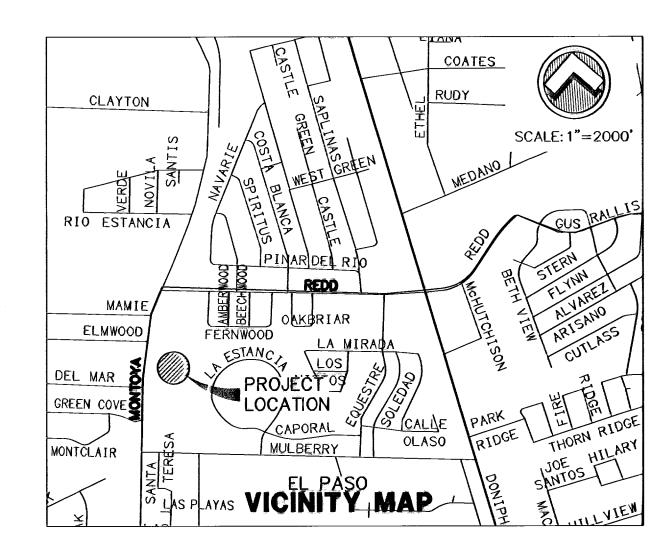

Approx. Latitude = 31°86'N Approx. Longitude = 106°60'W


STORM WATER POLLUTION PREVENTION PLAN

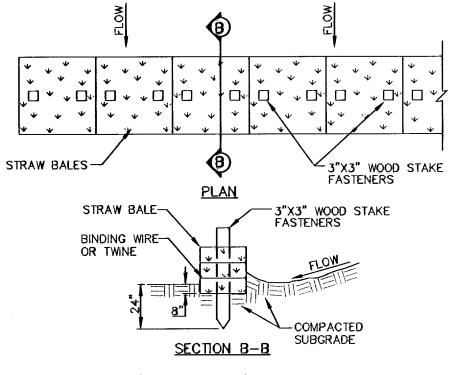

NOTES (BALE BARRIER):

- 1. BALES TO BE PLACED PERPENDICULAR TO FLOW HAY BALES PLACED IN "V" DITCH MUST BE STAGGERED.
- 2. BALES MUST BE FIRMLY STAKED INTO THE ENTRENCHMENT AND THE ENTRENCHMENT
- BE PROPERLY BACKFILLED. 3. BALES MUST BE PLACED END TO END AND THERE CAN BE NO GAPS BETWEEN THE BALES.
- 4. BARRIERS MUST BE INSPECTED AND REPAIRED IMMEDIATELY AFTER EACH RAINFALL OR DAILY IF THERE IS PROLONGED RAINFALL.
- 5. DAMAGED STRAW BALES REQUIRE IMMEDIATE REPLACEMENT.
- 6. TRAPPED SEDIMENTS MUST BE REMOVED AND DISPOSED OF PROPERLY.


STRAW BALE BARRIER

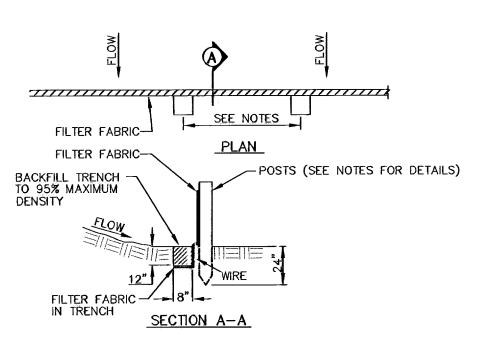

NOTES:

- 2. INSPECT THE FENCE AFTER EACH RAINFALL.
- 3. CHECK FOR AREAS WHERE RUN-OFF HAS ERODED A CHANNEL BENEATH THE FENCE, OR WHERE THE FENCE WAS CAUSED TO SAG OR COLLAPSE.
- 4. ALL NEEDED REPAIRS SHALL BE PERFORMED IMMEDIATELY.
- 5. REMOVE AND PROPERLY DISPOSE OF SEDIMENT WHEN IT IS ONE—THIRD TO ONE—HALF THE HEIGHT OF THE FENCE OR AFTER EACH
- 6. 4' MIN. STEEL OR WOOD POSTS SPACED AT 6' O.C. SOFTWOOD POSTS SHALL HAVE A 3" MIN. DIAMETER OR NOMINAL 2"x4". HARDWOOD POSTS SHALL HAVE A MINIMUM CROSS SECTION OF 1.5"x1.5"

FILTER FENCE
SCALE: 1" = 5'-0"

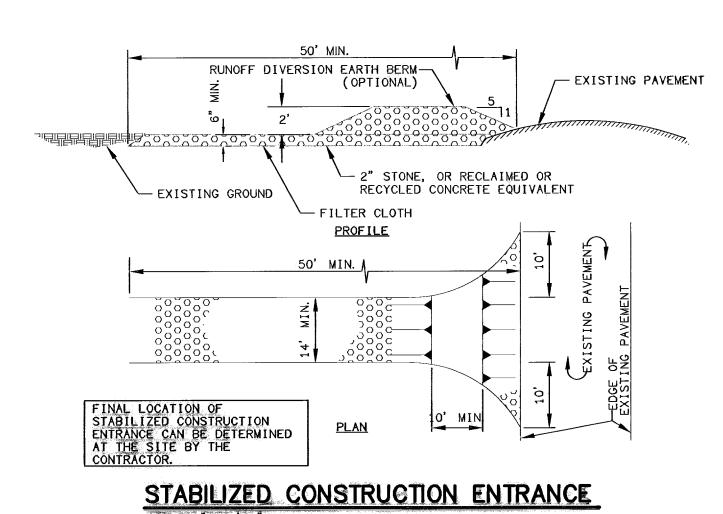

SW3P# 06-00287

WARNING !

CONTRACTOR SHALL FIELD LOCATE ALL EXISTING UNDERGROUND IMPROVEMENTS

BEFORE YOU DIG -EL PASO ELECTRIC COMPANY TEXAS GAS SERVICE EMERGENCY HOTLINE PUBLIC SERVICE BOARD (WATER & SEWER)

EL PASO NATURAL GAS CO.

CALL 543-5720 544-6300 775-7414 TIME WARNER COMMUNICATIONS (CABLE) TEXAS EXCAVATION SAFETY SYSTEM

—— - - LOT LINE ————— UTILITY EASEMENT 1-800-DIG-TESS ----- CENTER LINE OF STREET

<u>LEGEND</u> DIRECTION OF RUNOFF FLOW PROPOSED CITY MONUMENT SEE DETAIL SHT 10 LOW POINT

PROPOSED TOP OF CURB FINISHED GRADES (3729.2) EXISTING GRADE THC=08.09 HEADER CURB ELEVATION PVMT=08.65 PROPOSED PAVEMENT ELEVATION

DATE DESCRIPTION 04-15-08 RECORD DRAWING 3 10-11-07 FINAL CITY SUBMITTAL 2 10-05-0 J.C.K 2nd CITY SUBMITTAL 1 09-20-0 1ST CITY SUBMITTAL

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BENCHMARK: CITY MONUMENT AT THE WESTERLY CENTERLINE INTERSECTION OF FERNWOOD CIRCLE AND REDD ROAD. RECORD DRAWING ELEVATION = 3741.43 (CITY OF EL PASO DATUM) csa design group

09/20/07 DATE REDD ROAD ESTATES SUBDIVISION SHEET NO. STORM WATER POLLUTION PREVENTION PLAN 13

BEFORE YOU DIG

IN PROJECT AREA

562-8411/562-2003 1-800-DIG-TESS 1-800-334-8047 1-800-344-8377

BOUNDARY

HIGH POINT

VERTICAL INTERSECTION

1845 Northwestern Dr. Ste C El Paso, Texas 79912 tel [915] 877.4155 fax [915] 877.4334 www.csaengineers.com

IARRATIVE:			CONSTRUCTION (STORM WATER MANAGEMENT) ACTIVITIES:				
REDD ROAD ESTATES SUBDIVISION		1. BEGIN CONSTRUCTION	N/MOBOLIZATION (5 DAYS).				
EL PASO, TEXAS		2. INSTALL INITIAL STO	RMWATER POLLUTION PREVENTIONS (SWPP) MEASURES AS				
EGAL DESCRIPTION		INDICATED ON SWPP PL 3. CLEAR AND GRUB (2					
BEING ALL OF TRACTS 21B,21D, 21B1A		 CLEAR AND GRUB (2 WEEKS). SITE GRADING (2 MONTHS). PERFORM PERIODIC INSPECTIONS OF THE SWPP STRUCTURES. PERFORM MAINTENANCE AND REPLACEMENTS AS NEEDED (DURATION OF CONSTRUCTION). 					
AND 21B1B, BLOCK 6, UPPER VALLEY SURVEY, CITY OF EL PASO COUNTY, EL							
PASO, TEXAS		6. EXCAVATION FOR SI	TE UTILITIES AND STORM SEWER (3 MONTHS).				
EROSION AND SEDIMEN	r control	8. END CONSTRUCTION	SITE IMPROVEMENTS AND STORM SEWER (3 MONTHS). — FINAL STABILIZATION, DEMOBILIZATION, REMOVAL OF SWPP				
	i con mor	CONTROLS, AND SUI	BMIT NOTICE OF TERMINATION.				
OIL STABILIZATION PRACTICES			GENERAL CONTRACTOR CERTIFICATION				
TEMPORARY SEEDING		L CERTIEY LINDER DENAL	The state of the s				
PERMANENT PLANTING, SODDIN	IG, OR SEEDING	THE TEXAS POLLUTANT DIS	TY OF LAW THAT I UNDERSTAND THE TERMS AND CONDITIONS (CHARGE ELIMINATION SYSTEM (TPDES) GENERAL PERMIT THAT DISCHARGES ASSOCIATED WITH CONSTRUCTION ACTIVITY FROM FIED AS PART OF THIS CERTIFICATION.				
MULCHING		CONSTRUCTION SITE IDENTIF	FIED AS PART OF THIS CERTIFICATION.				
SOIL RETENTION BLANKET							
BUFFER ZONES		SIGNED:					
PRESERVATION OF NATURAL R	ESOURCES	NAME:					
OTHER:		TITLE:	DATE				
							
T	-TEMPORARY)	•	SUB - CONTRACTOR CERTIFICATION				
SILT FENCES		I CERTIFY UNDER PENAL	TY OF LAW THAT I WILL COORDINATE, EITHER THROUGH THE GE DIRECTLY, WITH THE CONTRACTOR(S) AND/OR SUBCONTRACTOR(S) TION PLAN HAVING RESPONSIBILITY FOR IMPLEMENTING STORM W NIMIZE ANY IMPACT MY ACTIONS MAY HAVE ON THE EFFECTIVEN ROLS MEASURES.				
HAY BALES		IN THE POLLUTION PREVEN	TION PLAN HAVING RESPONSIBILITY FOR IMPLEMENTING STORM W				
ROCK BERMS		THESE STORM WATER CONT	ROLS MEASURES.				
DIVERSION, INTERCEPTOR, OR							
DIVERSION, INTERCEPTOR, OR		SIGNED:					
DIVERSION DIKE AND SWALE C	OMBINATIONS	NAME:					
PIPE SLOPE DRAINS		TITLE:					
CONCRETE FLUMES		COMPANY:					
T ROCK BEDDING AT CONSTRUCT	TON EXIT	ADDRESS:					
TIMBER MATTING AT CONSTRUC	CTION EXIT	TELEPHONE:					
CHANNEL LINERS		DATE:	DATE:				
SEDIMENT TRAPS							
SEDIMENT BASINS			<u>OPERATOR</u>				
STORM INLET SEDIMENT TRAP		SIGNED:	COMPANY:				
STONE OUTLET STRUCTURES		NAME:	ADDRESS:				
P CURBS AND GUTTERS		TITLE:					
STORM DRAINS			DATE:				
VELOCITY CONTROL DEVICES							
P NATURAL SWALES & NATURAL	DEPRESSIONS						
OTHER:	1.5.4.30		SOIL CONDITIONS				
OHEN.	- 10 - 1 (1 - 1 - 1 - 1 - 1 - 1 - 1 - 1 - 1		ORINGS WERE DRILLED TO DEPTHS RANGING FROM 8 TO 15 STING GROUND SURFACE. THE SOIL UNDERLYING THE SITE				
		GENERALLY CONSISTS	OF THREE MAJOR SOIL TYPES. THE NEAR SUBSURFACE SOILS				
	RUCTION CONTROLS		WN, SILTS, (2) BROWN, LOW TO HIGHLY PLASTIC CLAYS AND (3) INED, POORLY GRADED SANDS AND/OR SILTY SANDS.				
	ASIN, EARTH BERMS AND INNELS AS PER PLAN	THE TO MEDIOM ONA	THE STATE OF THE S				
	SIZE, DISTURBED AREA						
PROJECT SITE APPR			ENDANGERED SPECIES ACT				
ESTIMATED DISTURB	D AREA 12.33 ACRES.		KELY TO ADVERSELY AFFECT ANY CURRENTLY FEDERAL THREATENED OR ENDANGERED SPECIES.				
		2.0125	TESTINE WILLIAM SIVE ENDINGERED SIVES.				
			HISTORIC PROPERTY SITE				
CONSTRUCTION START DATE:	CONSTRUCTION END DATE:	NO K	NOWN SITES ELIGIBLE FOR HISTORIC RECORD				
		MITHORIZED	STORM WATER DISCHARGES				
		The second of th	The State of the S				
		1. STORM W	ATER ASSOCIATED WITH CONSTRUCTION ACTIVITY.				
			ES OF STORM WATER ASSOCIATED WITH CONSTRUCTION SUPPOR				
			NCLUDING CONCRÈTE AND ASPHALT BATCH PLANTS, EQUIPMENT EAS, MATERIAL STORAGE YARDS, MATERIAL BORROW AREAS, ANI				
		EXCAVATED SERVIT NO	MATERIAL DISPOSAL AREAS MAY BE AUTHORIZED AS PER TPDES TXR1500000, PART II, SECTION A.				
		<u>AUTHORIZED</u> THE FOLLOW	NON-STORM WATER DISCHARGES ING NON-STORM WATER DISCHARGES AREA AUTHORIZED AS PER				
		TPDES PERM	IT NO. TXR150000, PART II, SECTION A.				
		1. DISCHARG	ES FROM FIRE FIGHTING ACTIVITIES.				
		a FIDE LIVE	DANT CHICHING				
		Z. FIRE HTD.	RANT FLUSHING.				
		3. WATER US	SED TO CONTROL DUST.				
		4. WATER LI	NE FLUSHING.				
		5 VEHICLE	EXTERNAL BUILDING AND PAVEMENT WASH WATER, FREE OF				
			AND SOAPS.				
		6. AIR COND	DITIONING CONDESATE.				
		1. CONCRETE					
		2. DETERGEN 3. PAINTS					
		4. CLEANING	SOLVENTS				
		5. FUELS	AL EQUIPMENT AND MATERIALS				
		7. LUBRICAN					
		8. WOOD 9. FERTILIZE	RS				
		10. ASPHALT	T AND ASPHALT RELATED PRODUCTS				
		11. STEEL P	RODUCTS				

I WASTE MATERIALS: ALL SANITARY WASTE SHALL BE COLLECTED FROM THE CONSTRUCTION PORTABLE UNITS AS NECESSARY OR AS REQUIRED, CHAPTER 18.08 (BUILDING CODE), BY A LICENSED SANITARY WASTE MANAGEMENT CONTRACTOR. ALL WASTE MATERIAL SHALL BE THE RESPONSIBILITY OF THE CONTRACTOR. THE FOLLOWING PRACTICES SHALL BE USED TO REDUCE THE RISK OF SPILLS OR OTHER ACCIDENTAL EXPOSURES OF MATERIALS TO STORM WATER RUNOFF. V GOOD HOUSEKEEPING: A. STORE ONLY ENOUGH PRODUCTS REQUIRED TO DO THE JOB B. NEATLY STORE MATERIALS ON-SITE IN AN ORDERLY MANNER C. KEEP PRODUCTS IN THEIR ORIGINAL CONTAINER D. DO NOT MIX SUBSTANCES WITH ONE ANOTHER, UNLESS OTHERWISE RECOMMENDED BY THE MANUFACTURER E. USE ENTIRE CONTENTS OF A PRODUCT BEFORE DISPOSING THE CONTAINER F. FOLLOW MANUFACTURER'S RECOMMENDATIONS FOR PROPER USE AND DISPOSAL VI HAZARDOUS PRODUCTS: PRACTICES USED TO REDUCE RISKS: A. KEEP PRODUCTS IN THEIR ORIGINAL CONTAINER IF AT ALL POSSIBLE B. RETAIN ORIGINAL LABELS, PRODUCT INFORMATION AND MATERIAL SAFETY DATA SHEETS (MSDS) C. DISPOSE SURPLUS PRODUCT IN ACCORDANCE WITH MANUFACTURER'S OR LOCAL & STATE RECOMMENDED METHODS POSSIBLE POLLUTANTS ON-SITE A. GAS TANK CONTAINERS 1. INSPECT CONTAINERS FOR LEAKS AND ENSURE LIDS AND CAPS ARE PROPERLY SEALED. DAMAGED TANKS OR CONTAINERS SHALL BE PROPERLY REMOVED/REPLACED AND DISPOSED OF. B. LUBRICATING GREASE CONTAINERS 1. ALL ON-SITE VEHICLES SHALL BE MONITORED FOR LEAKS AND RECEIVE REGULAR PREVENTATIVE MAINTENANCE TO REDUCE CHANCE OF LEAKAGE; DRIP PANS SHALL BE UTILIZED FOR LEAKING VEHICLES AND FOR FLUID DRAINING. C. CEMENT DISCHARGE INTO EXISTING STORM SYSTEM 1. ONSITE INSPECTIONS OF CONCRETE POUR AREAS SHALL BE DONE TO ENSURE THAT CEMENT DOES NOT RUNOFF AND DISCHARGE INTO EXISTING STORM SEWER SYSTEM. VIII SPILL CONTROL PRACTICES: A. MANUFACTURER'S RECOMMENDED METHODS FOR SPILL CLEANUP SHALL BE CLEARLY POSTED AND SITE PERSONNEL SHALL BE MADE AWARE OF THE B. MATERIALS AND EQUIPMENT NECESSARY FOR SPILL CLEANUP SHALL BE KEPT IN THE MATERIAL STORAGE AREA ON-SITE:

C. ALL SPILLS SHALL BE CLEANED UP IMMEDIATELY AFTER DISCOVERY

D. SPILL AREA SHALL BE WELL VENTILATED AND APPROPRIATE CLOTHING WILL BE WORN:

F. MEASURES SHALL BE TAKEN TO PREVENT A SPILL FROM REOCCURRING

E. ANY SPILL SHALL BE REPORTED TO THE APPROPRIATE GOVERNMENTAL AGENCY

BEST MANAGEMENT PRACTICES CONTROLS

IX MAINTENANCE AND INSPECTION PROCEDURES:

ALL POLLUTION PREVENTION MEASURES SHALL BE INSPECTED AT LEAST ONCE EVERY 7 DAYS AND FOLLOWING A STORM EVENT OF 0.5 INCHES OR MORE. INSPECTION IN FINAL STABILIZED AREAS OR DURING ARID PERIODS WILL BE CONDUCTED BI-WEEKLY. BEST MANAGEMENT PRACTICES AND POLLUTION CONTROL PROCEDURES SHALL BE INSPECTED FOR ADEQUACY. A REPORT SUMMARIZING THE SCOPE OF INSPECTION SHALL BE DONE & RETAINED ALONG WITH

REMARKS:

XI OFFSITE VEHICLE TRACKING:

IN ADDITION TO THE STABILIZED CONSTRUCTION ENTRANCES, THE FOLLOWING MEASURES SHALL BE OBSERVED DURING CONSTRUCTION:

MATERIALS WITH CONSTRUCTION SITE: ____ HAS BATCH PLANT WITH PROJECT

HAS ASPHALT PLANT WITH PROJECT

MODES NOT HAVE BATCH PLANT WITH PROJECT MODES NOT HAVE ASPHALT PLANT WITH PROJECT

OWNER : SIGNED

GENERAL NOTES

1. CONTRACTOR TO PROVIDE A CONSTRUCTION SIGN ONSITE, CONSPICUOUSLY NEAR MAIN ENTRANCE, WITH A COPY OF N.O.I. POSTED. 2. CONTRACTOR TO DESIGNATE A QUALIFIED COMPETENT PERSON TO INSPECT AND

RECORD SW3P AND BMP INSPECTION IN ACCORDANCE TO SITE INSPECTION REPORT. 3. CONTRACTOR TO KEEP ORIGINAL N.O.I. AND INSPECTION REPORTS ON SITE AT ALL TIMES. 4. CONTRACTOR SHALL BE RESPONSIBLE TO MAINTAIN A CLEAN WORK SITE. 5. CONTRACTOR MUST KEEP RECORD OF IMPORTANCE DATES SUCH AS, BUT NOT LIMITED TO, MAJOR GRADING ACTIVITIES, CONSTRUCTION TEMPORARILY OR

PERMANENTLY WORK CEASED, STABILIZATION MEASURES INITIATED. 6. CONTRACTOR SHALL KEEP A COPY OF TPDES PERMIT TXR 15000 ONSITE

NOTE:
CONTRACTOR SHALL ENSURE COMPLIANCE WITH SW3P AND TPDES PERMIT TXR 15000. PERMIT TXR 15000 IS LOCATED AND CAN BE VIEWED WITH THE CIVIL ENGINEER - CSA CONSULTING ENGINEERS, 1845 NORTHWESTERN DR, SUITE C, EL PASO, TX. 79912.

SW3P# 06-00287

WARNING ! BEFORE YOU DIG

CONTRACTOR SHALL FIELD LOCATE ALL EXISTING UNDERGROUND IMPROVEMENT IN PROJECT AREA

BEFORE YOU DIG -CALL 543-5720 EL PASO ELECTRIC COMPANY 1-800-DIG-TESS TEXAS GAS SERVICE 544-6300 EMERGENCY HOTLINE 562-8411/562-2003 1-800-DIG-TESS PUBLIC SERVICE BOARD (WATER & SEWER) 775-7414 TIME WARNER COMMUNICATIONS (CABLE) EL PASO NATURAL GAS CO. 1-800-334-8047 1-800-344-8377 TEXAS EXCAVATION SAFETY SYSTEM

—— - - LOT LINE ————— UTILITY EASEMENT BOUNDARY

----- CENTER LINE OF STREET

LEGEND DIRECTION OF RUNOFF FLOW SEE DETAIL SHT 10 LOW POINT

HIGH POINT

PROPOSED TOP OF CURB FINISHED GRADES 3728.85

(3729.2) EXISTING GRADE PROPOSED TOP OF HEADER CURB ELEVATION THC=08.09 PVMT=08.65 PROPOSED PAVEMENT ELEVATION VERTICAL INTERSECTION

DESCRIPTION NO. DATE 4 | 04-15-08 RECORD DRAWING 3 10-11-07 FINAL CITY SUBMITTAL 2 10-05-07 J.C.K 2nd CITY SUBMITTAL 1 09-20-07 1ST CITY SUBMITTAL

JOHN C. KARLSRUHER 53878 (c. 53878) (c. 538788) (c. 53878) (c. 538788) (c. 53878) (c. 53878) (c. 538788) (c. 53878) (c. 538788) (c. 53878) (c. 53878) (c. 53878) (c. 53878) (c. 53878) (c. 53878) (J.C.K

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BENCHMARK: CITY MONUMENT AT THE WESTERLY CENTERLINE INTERSECTION OF FERNWOOD CIRCLE AND REOD ROAD. RECORD DRAWING ELEVATION = 3741.43 (CITY OF EL PASO DATUM) csa design group 5044 JOB NO. 1845 Northwestern Dr. Ste C El Paso, Texas 79912 09/20/07 DATE

REDD ROAD ESTATES SUBDIVISION

AS NOTED · 14